

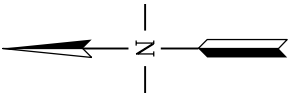
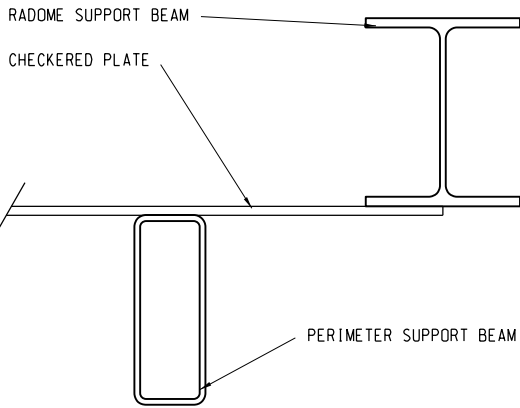


NOTES:


1. MATERIAL: 3/8" CHECKERED PLATE MEDIUM PATTERN.
2. SEE SHEET S000 FOR APPLICABLE NOTES.
3. FINAL FINISH: OVER HOT DIP GALVANIZED BASE, APPLY A NON-SKID COATING USING INTERNATIONAL INTERSEAL 670 MIXED WITH DRY SILICA SAND, COLOR ALUM. GRAY.
4. SEE S036 FOR ADDITIONAL DIMENSIONAL INFORMATION NOT SHOWN

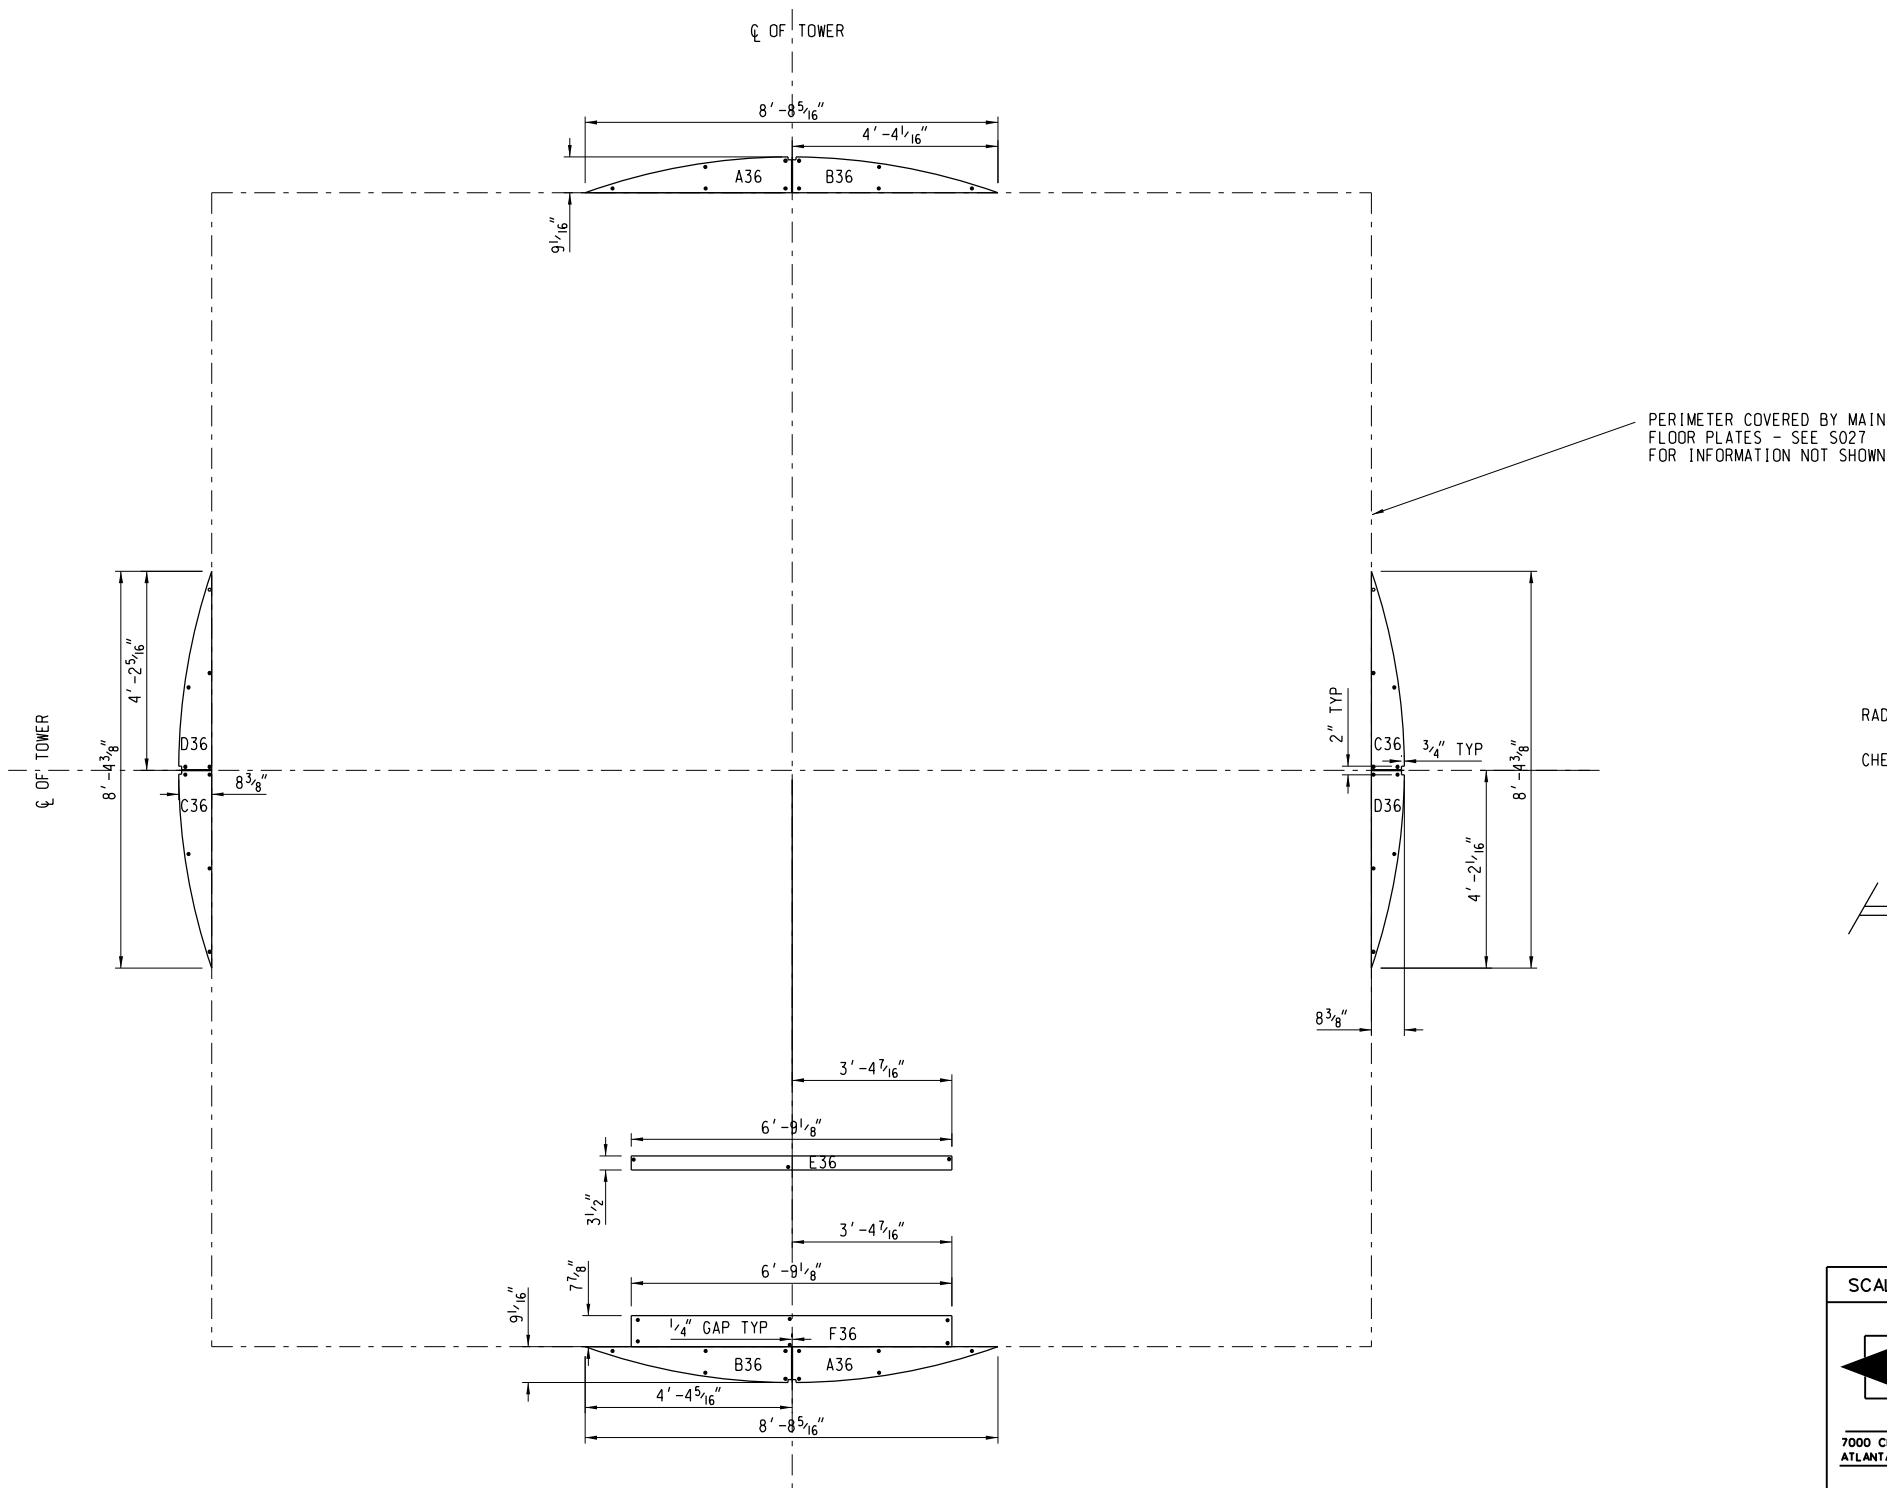


1 TOP LEVEL EDGE PLATES  
S035 SCALE: 1/2" = 1'-0"

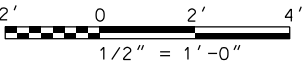


SCALES SHOWN FOR 22" X 34" SHEET. ADJUST SCALES FOR OTHER SIZES.										
<div><div></div><div>HARTRAMPF</div></div> <div>7000 CENTRAL PARKWAY, SUITE 1475 ATLANTA, GEORGIA 30328</div> <div>HEI JOB NUMBER: 212042.00</div>										
REV	APPROVED DATE	DESCRIPTION				JCN	REDLINE DATE	APVD		
DEPARTMENT OF TRANSPORTATION FEDERAL AVIATION ADMINISTRATION ATO TECHNICAL OPERATIONS EASTERN SERVICE AREA										
ATCBI ATCBI-6 TOP PLATFORM TREADPLATE LAYOUT										
FREEPORT				BAHAMAS						
REVIEWED BY		SUBMITTED BY				APPROVED BY				
		NEIL BOLEN				STEVE BRADDY				
		DESIGNED	SNG	ISSUED BY		DATE	4/23/2012	JCN	621767	
		DRAWN	SNG	ENGINEERING SERVICES		DRAWING NO			REV	
		CHECKED	RAB	SURV/WEATHER		BHF-D-621767-S035				

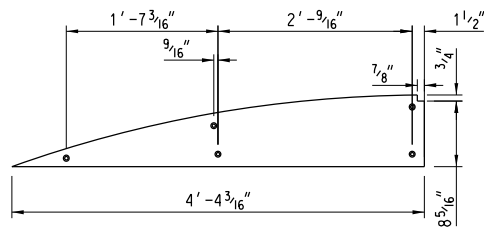


**A** A36 -  
CHK'D PLATE  
S036 SCALE: 1" = 1'-0"

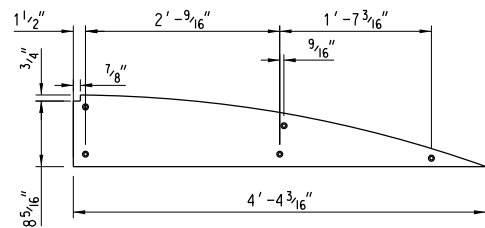


**B** B36 -  
CHK'D PLATE  
S036 SCALE: 1" = 1'-0"

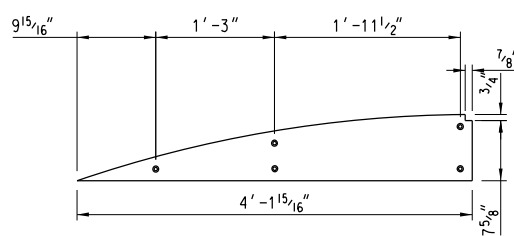


**C** C36 -  
CHK'D PLATE  
S036 SCALE: 1" = 1'-0"

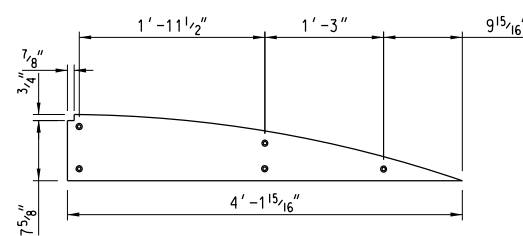


**D** D36 -  
CHK'D PLATE  
S036 SCALE: 1" = 1'-0"

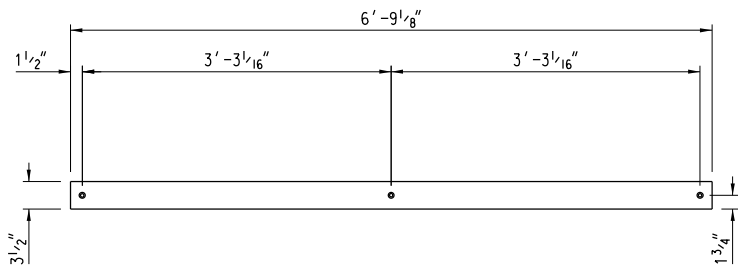


**E** E36 -  
CHK'D PLATE  
S036 SCALE: 1" = 1'-0"

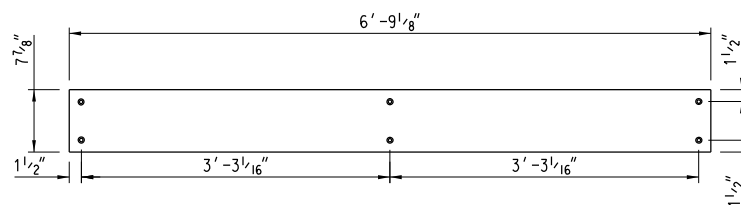


**F** F36 -  
CHK'D PLATE  
S036 SCALE: 1" = 1'-0"

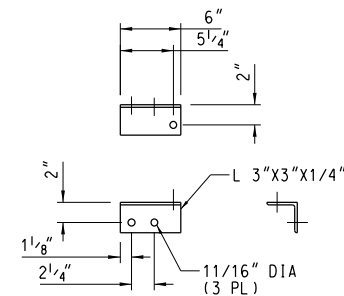


**A** ANGLE AS SHOWN-"A36R" (QTY 1)  
S036 ANGLE OPPOSITE-"A36L" (QTY 1)  
NOT TO SCALE

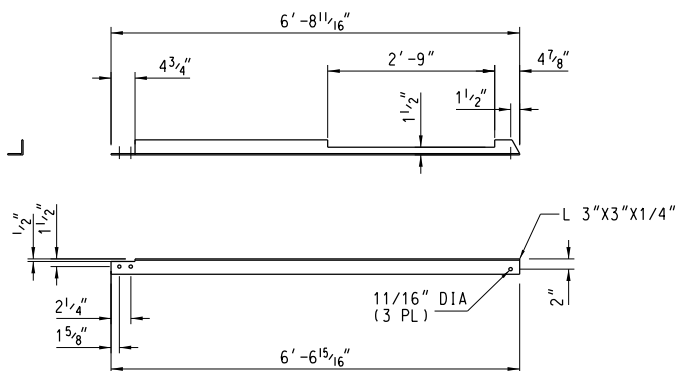


**D** ANGLE AS SHOWN-"D36" (QTY 1)  
S036 NOT TO SCALE

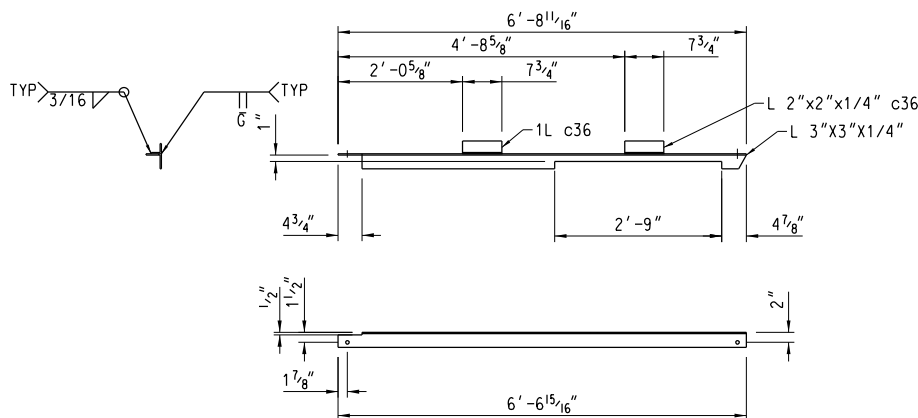


**B** ANGLE AS SHOWN-"B36" (QTY 1)  
S036 NOT TO SCALE

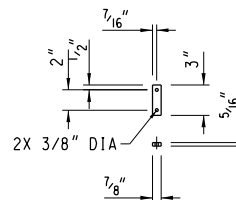

**E** PLATE AS SHOWN-"E36" (QTY 2)  
S036 NOT TO SCALE

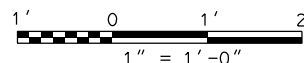


SCALES SHOWN FOR 22" X 34" SHEET. ADJUST SCALES FOR OTHER SIZES.									
7000 CENTRAL PARKWAY, SUITE 1475 ATLANTA, GEORGIA 30328 HEI JOB NUMBER: 212042.00									
DEPARTMENT OF TRANSPORTATION FEDERAL AVIATION ADMINISTRATION ATO TECHNICAL OPERATIONS EASTERN SERVICE AREA									
ATCBI ATCBI-6 TOP PLATFORM TREADPLATE FASTENER & BEAM DETAILS									
FREEPORT BAHAMAS									
REVIEWED BY		SUBMITTED BY NEIL BOLEN			APPROVED BY STEVE BRADY				
		DESIGNED SNG			ISSUED BY ENGINEERING SERVICES SURV/WEATHER		DATE 4/23/2012		JCN 621767
		DRAWN SNG					DRAWING NO		REV
		CHECKED RAB					BHF-D-621767-S036		

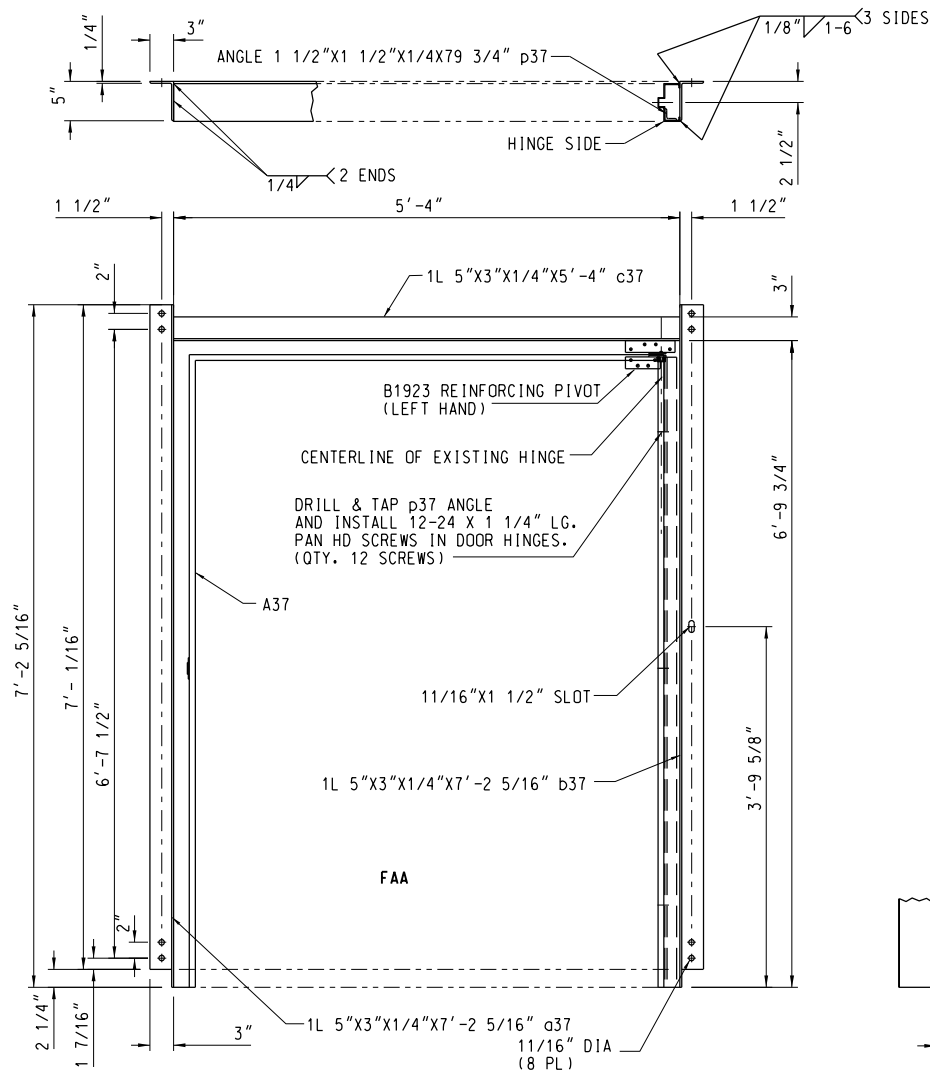


NOTE: 4 1/2" DEPTH, 16 GA GALVANIZED, RIGHT HAND SWING F-16-4, STEELCRAFT


**A** DOOR FRAME - "A37"  
S037 NOT TO SCALE

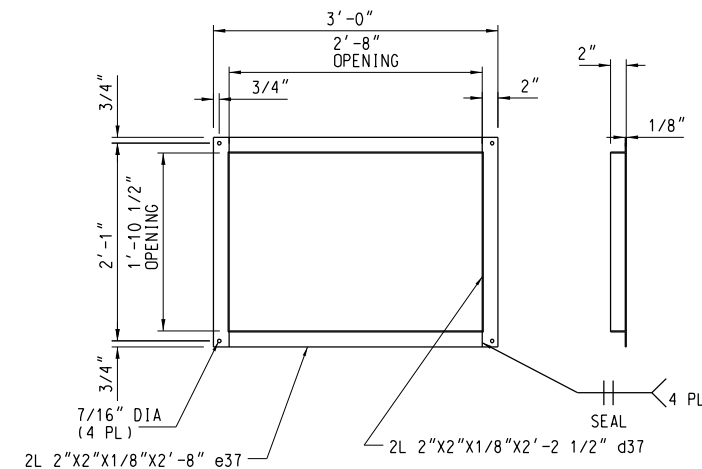


**B** WAVEGUIDE FRAME - "B37" (QTY 1)  
S037 NOT TO SCALE

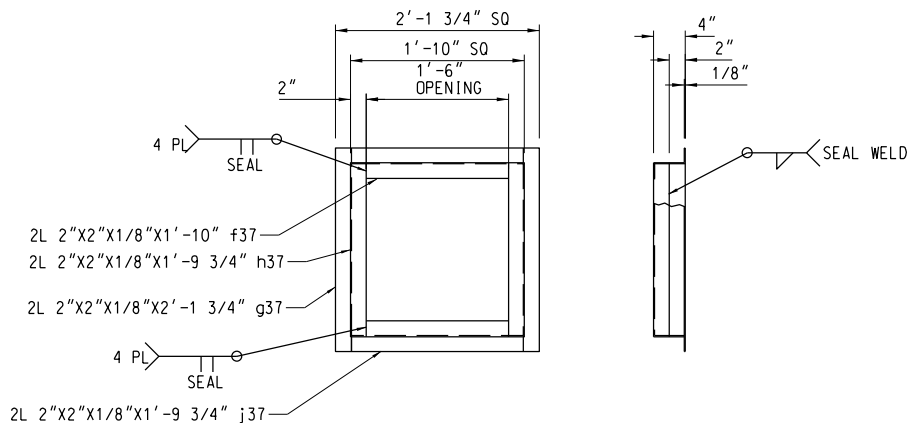

**C** LOUVER FRAME - "C37" (QTY 2)  
S037 NOT TO SCALE

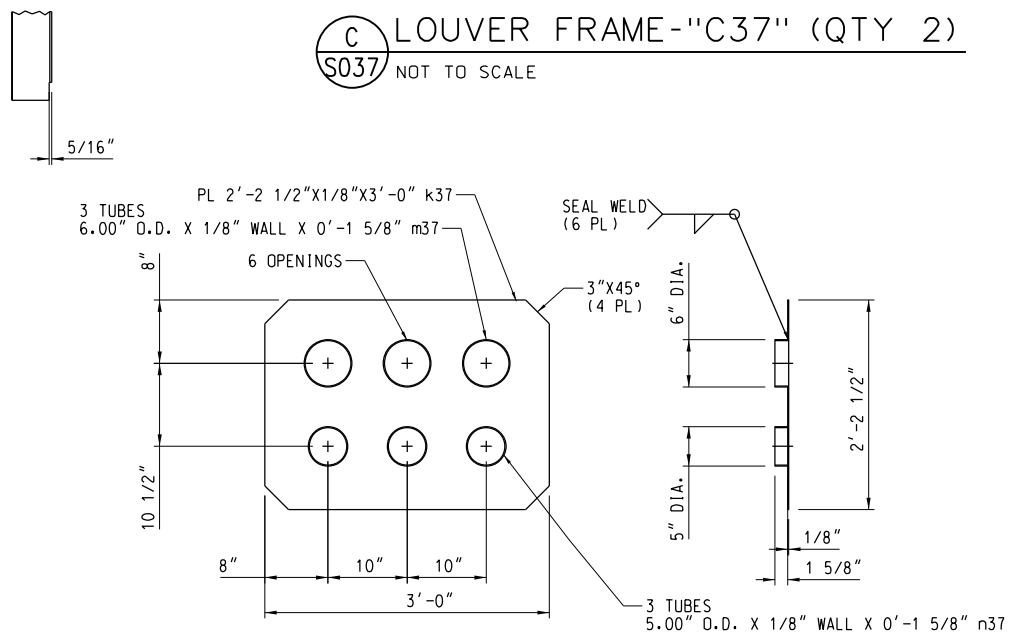


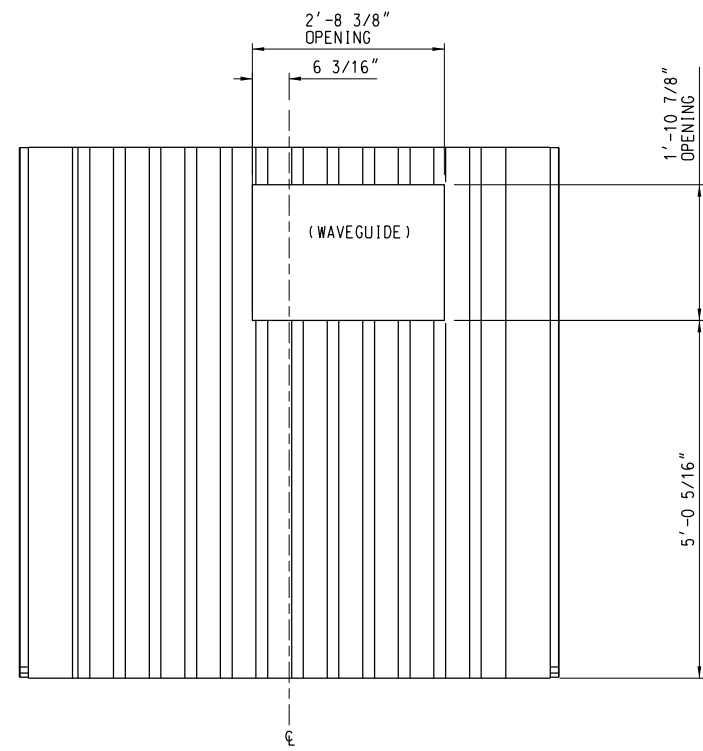
**E** WAVEGUIDE PLATE - "E37" (QTY 1)  
S037 NOT TO SCALE

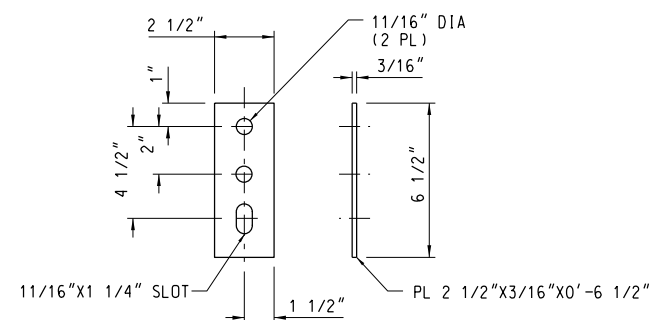



**D** MOUNTING PLATE - "D37" (QTY 4)  
S037 NOT TO SCALE

PARTS USED ON ASSEMBLY S125

SCALES SHOWN FOR 22" X 34" SHEET. ADJUST SCALES FOR OTHER SIZES.										
<div></div> <div>7000 CENTRAL PARKWAY, SUITE 1475 ATLANTA, GEORGIA 30328</div> <div>HEI JOB NUMBER: 212042.00</div>										
REV	APPROVED DATE	DESCRIPTION				JCN	REDLINE DATE		AP	
DEPARTMENT OF TRANSPORTATION FEDERAL AVIATION ADMINISTRATION ATO TECHNICAL OPERATIONS EASTERN SERVICE AREA										
ATCBI ATCBI-6 MEZZANINE LEVEL ENCLOSURE FRAMING DETAILS										
FREEPORT						BAHAMAS				
REVIEWED BY		SUBMITTED BY				APPROVED BY				
		NEIL BOLEN				STEVE BRADY				
		DESIGNED SNG		ISSUED BY		DATE 4/23/2012		JCN	621767	
		DRAWN SNG		ENGINEERING SERVICES		DRAWING NO		BHF-D-621767-S037		
		CHECKED RAB		SURV/WEATHER						




**A** VIEW  
S038 SCALE: 3/4" = 1'-0"

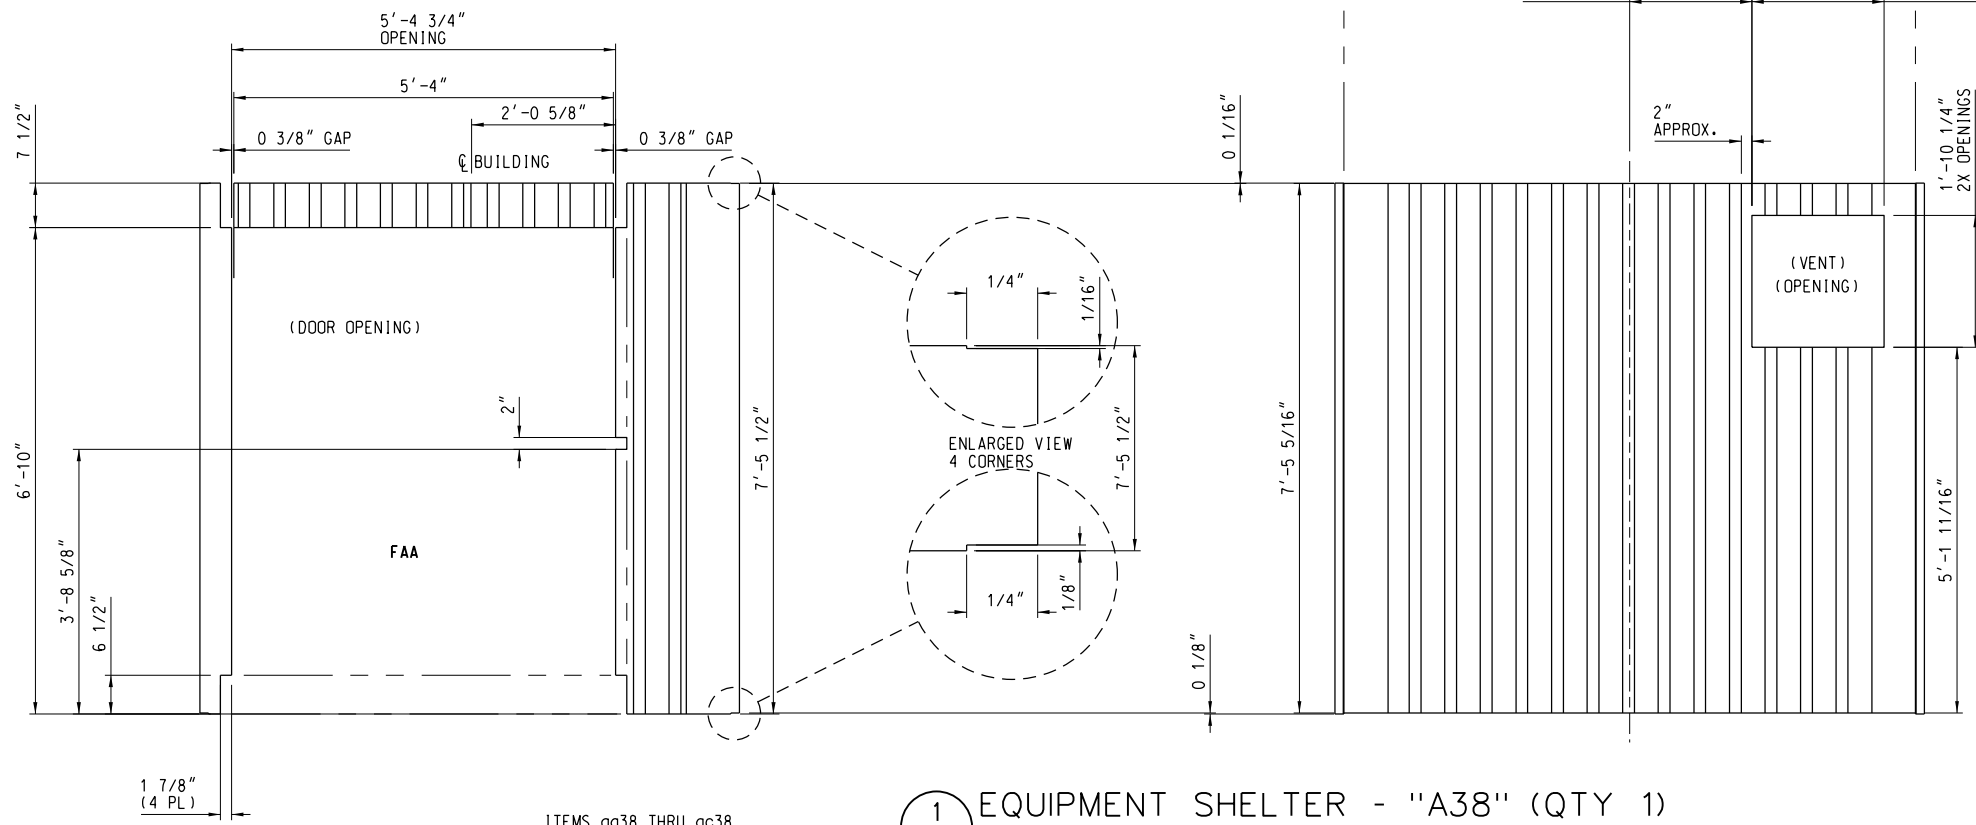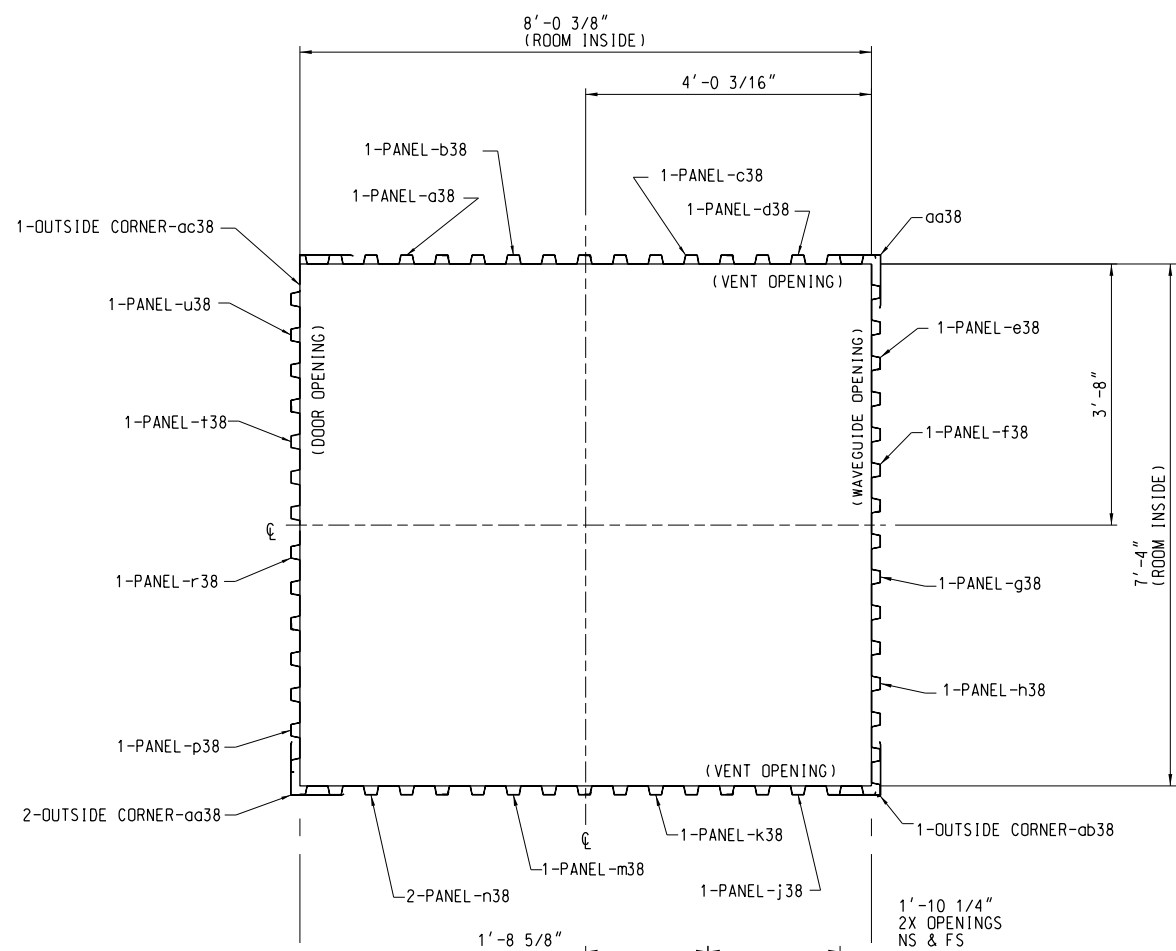

ITEMS aa38 THRU ac38  
OUTSIDE CORNER, GALVANIZED STEEL  
FS-30-7, FLEXOSPAN

ITEMS a38 THRU u38  
PANEL, 20 GA. CORRUGATED GALVANIZED STEEL,  
1 1/2" DEPTH, 221 LBS/SQ FT ON 48" SUPPORTS  
E150-20GA, EPIC


**1** EQUIPMENT SHELTER - "A38" (QTY 1)  
S038 SCALE: 3/4" = 1'-0"

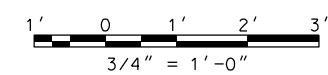


**A**  
S038

USED ON ASSEMBLY S125


SCALES SHOWN FOR 22" X 34" SHEET. ADJUST SCALES FOR OTHER SIZES.									
 7000 CENTRAL PARKWAY, SUITE 1475 ATLANTA, GEORGIA 30328 HEI JOB NUMBER: 212042.00									
DEPARTMENT OF TRANSPORTATION <b>FEDERAL AVIATION ADMINISTRATION</b> ATO TECHNICAL OPERATIONS EASTERN SERVICE AREA									
ATCBI ATCBI-6 MEZZANINE LEVEL ENCLOSURE DETAILS									
FREEMPORT					BAHAMAS				
REVIEWED BY	SUBMITTED BY				APPROVED BY				
	NEIL BOLEN				STEVE BRADDY				
DESIGNED	SNG	ISSUED BY		DATE		4/23/2012	JCN	621767	
DRAWN	SNG	ENGINEERING SERVICES		DRAWING NO		BHF-D-621767-S038		REV	
CHECKED	RAB	SURV/WEATHER							

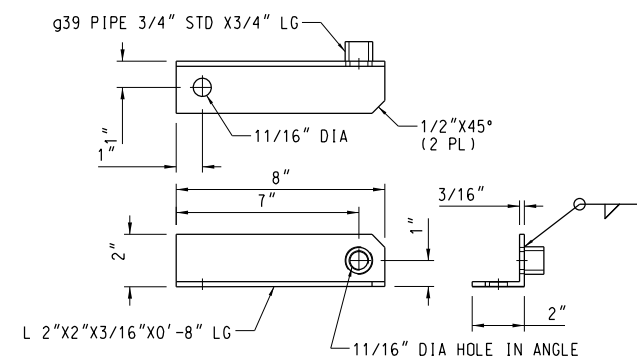

1 TOUCH UP BARE METAL USING ZINC RICH PAINT.

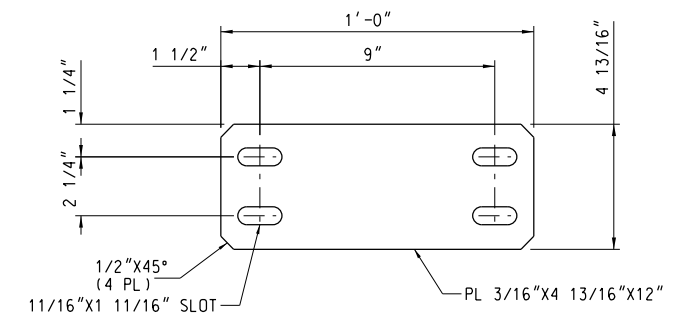


ANGLE SHOWN-"D39L" (QTY 1)  
ANGLE OPPOSITE-"D39R" (QTY 1)



 ANGLE C  
 ANGLE C  
 NOT TO SCALE

A BRACKET  
S039 NOT TO SCALE




 CABLE T  
 NOT TO SCALE



SCALES SHOWN FOR 22" X 34" SHEET. ADJUST SCALES FOR OTHER SIZES.																					
<div><div>HARTRAMPF</div><div>7000 CENTRAL PARKWAY, SUITE 1475 ATLANTA, GEORGIA 30328</div><div>HEI JOB NUMBER: 212042.00</div></div>																					
REV	APPROVED DATE		DESCRIPTION						JCN	REDLINE DATE		APVD									
DEPARTMENT OF TRANSPORTATION FEDERAL AVIATION ADMINISTRATION																					
ATO TECHNICAL OPERATIONS						EASTERN SERVICE AREA															
ATCB1 ATCB1-6 TYPICAL LEVEL CABLE TRAY BEAM DETAILS																					
FREEPORT						BAHAMAS															
REVIEWED BY		SUBMITTED BY						APPROVED BY													
		NEIL BOLEN						STEVE BRADY													
		DESIGNED		SNG		ISSUED BY		DATE		JCN											
		DRAWN		SNC		ENGINEERING SERVICES		4/23/2012		621767											
		CHECKED		RAR		SURV/WEATHER		DRAWING NO		REV											
								BHF-D-621767-S039													

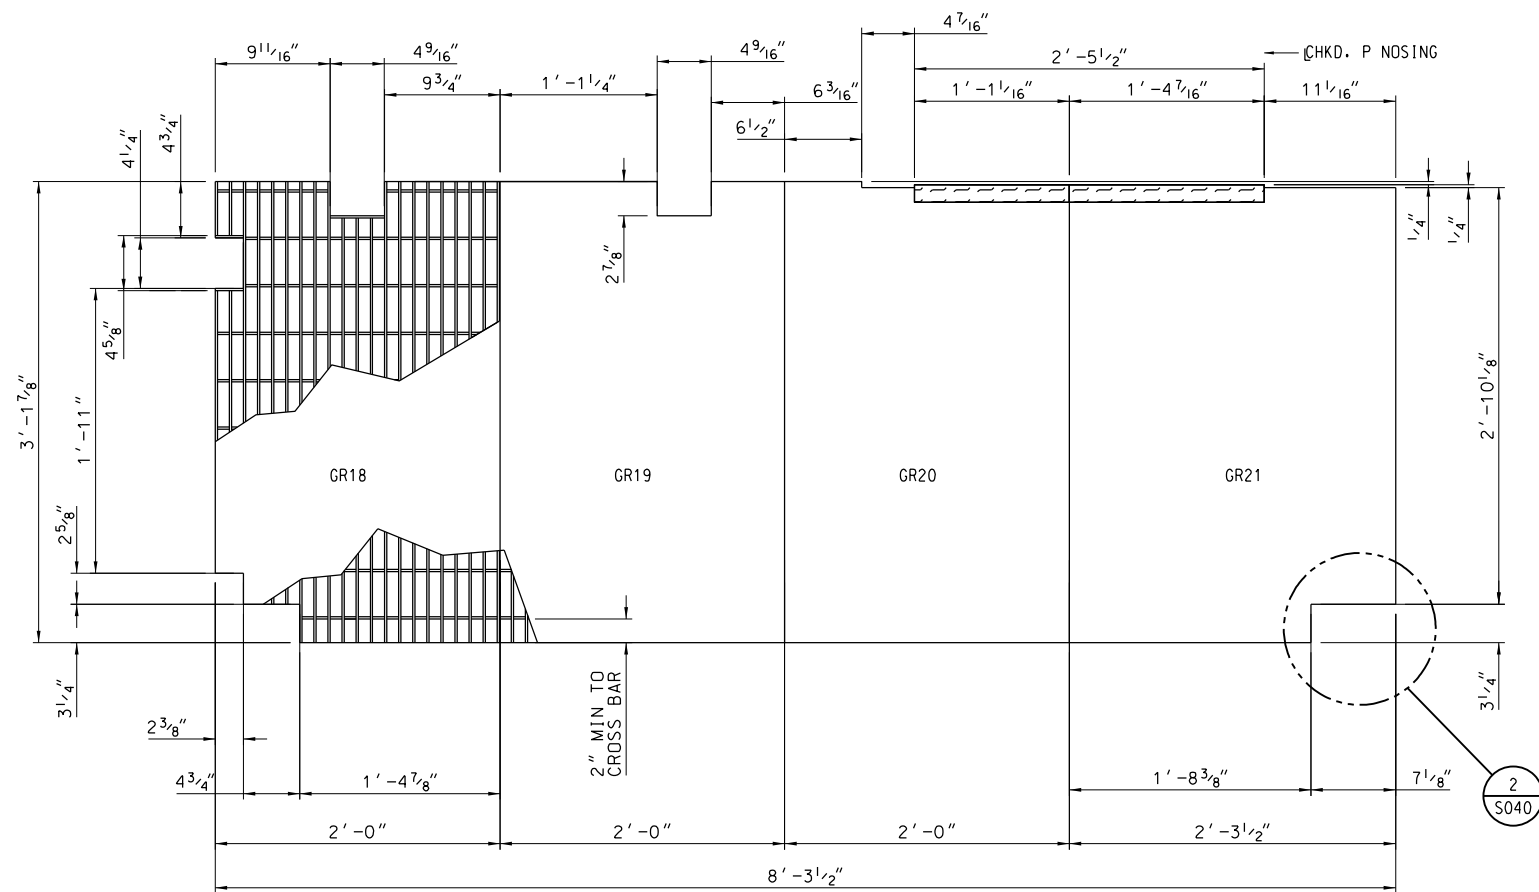

NOTE: GRATING TO BE HOT DIP GALVANIZED PER ASTM A123 AFTER FABRICATION  
ONE - GRATING - GR18      ONE - GRATING - GR20  
ONE - GRATING - GR19      ONE - GRATING - GR21











MATERIAL: 1 1/4" DEEP X 3/16" BEARING BARS ON 1 3/16" CENTERS BAR GRATING

1 PLATFORM GRATING  
S040 NOT TO SCALE

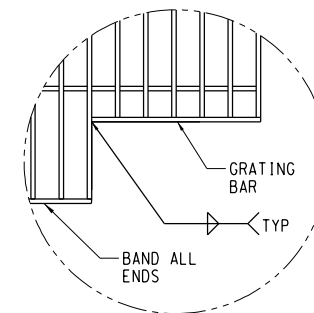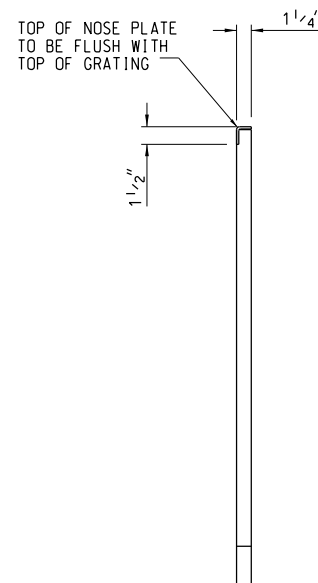


2 TYPICAL CUTOUT REINFORCEMENT  
S040 NOT TO SCALE


SCALES SHOWN FOR 22" X 34" SHEET. ADJUST SCALES FOR OTHER SIZES.									
<div><div><div>HARTRAMPF</div><div>7000 CENTRAL PARKWAY, SUITE 1475 ATLANTA, GEORGIA 30328 HEI JOB NUMBER: 212042.00</div></div><div><div>DEPARTMENT OF TRANSPORTATION FEDERAL AVIATION ADMINISTRATION ATO TECHNICAL OPERATIONS</div><div>ATCBI ATCBI-6 TYPICAL LANDING GRATING DETAILS</div><div>FREEPORTBAHAMAS</div></div></div>									
REV	APPROVED DATE	DESCRIPTION					JCN	REDLINE DATE	APVD
SUBMITTED BY NEIL BOLEN									
APPROVED BY STEVE BRADDY									
DESIGNED		SNG		ISSUED BY		DATE		JCN	
DRAWN		SNG		ENGINEERING SERVICES		4/23/2012		621767	
CHECKED		RAB		SURV/WEATHER		DRAWING NO		REV	
							BHF-D-621767-S040		

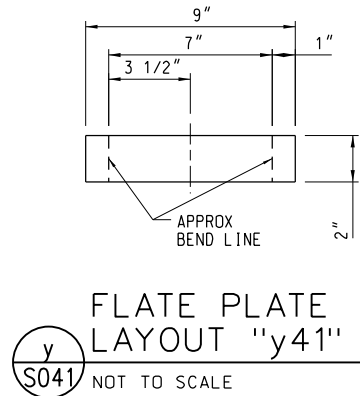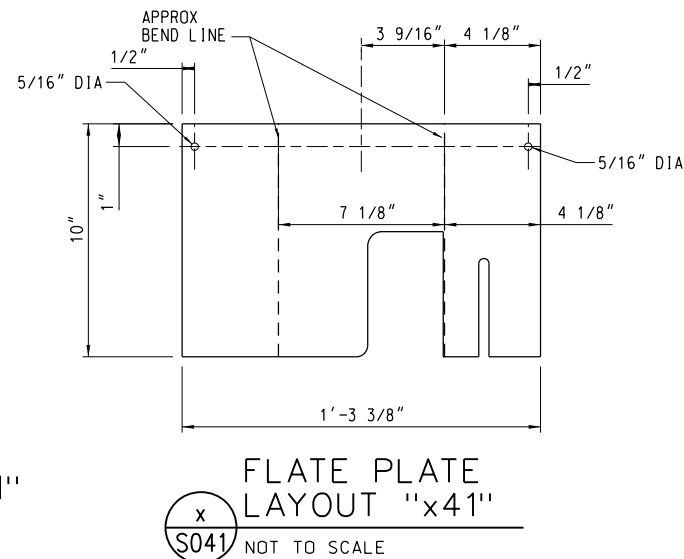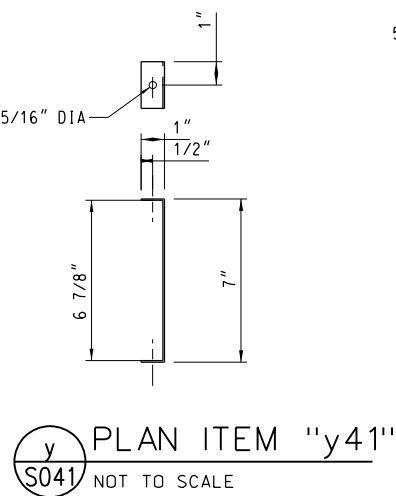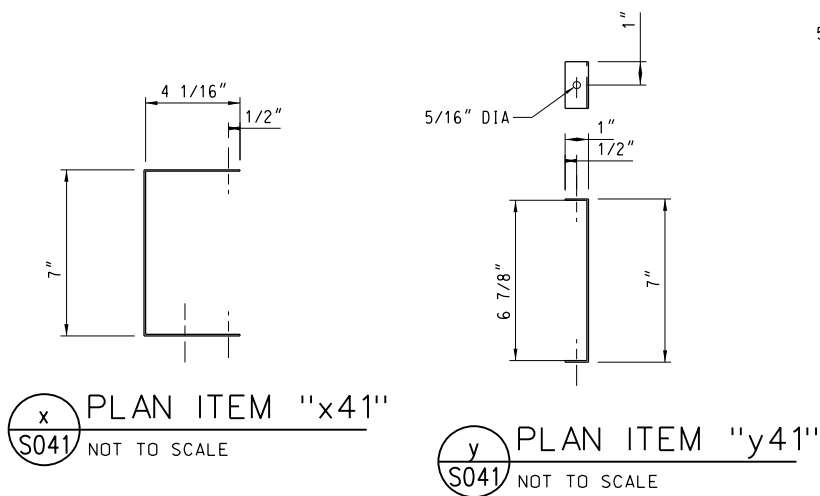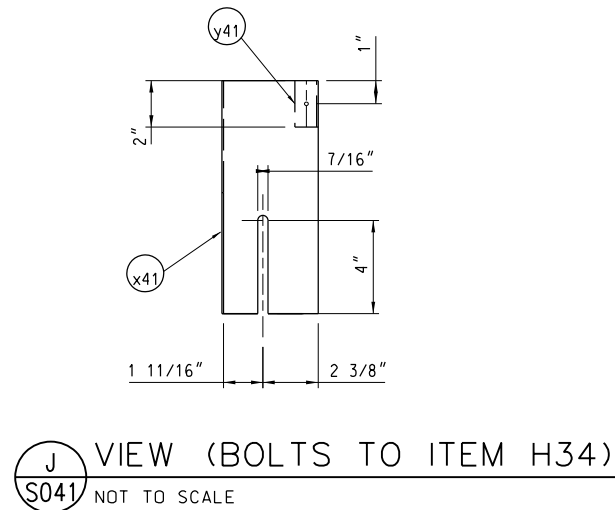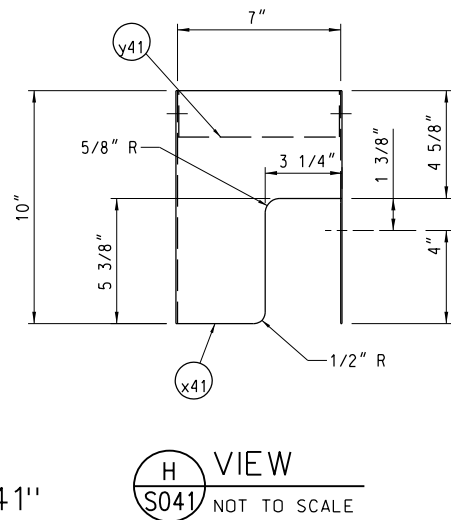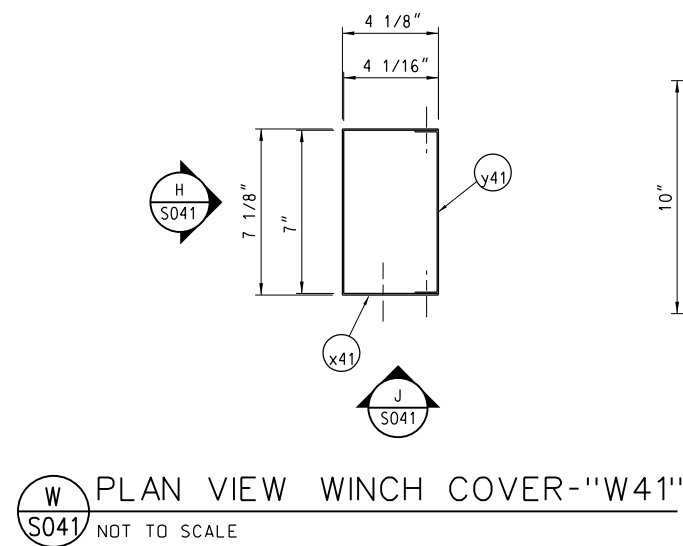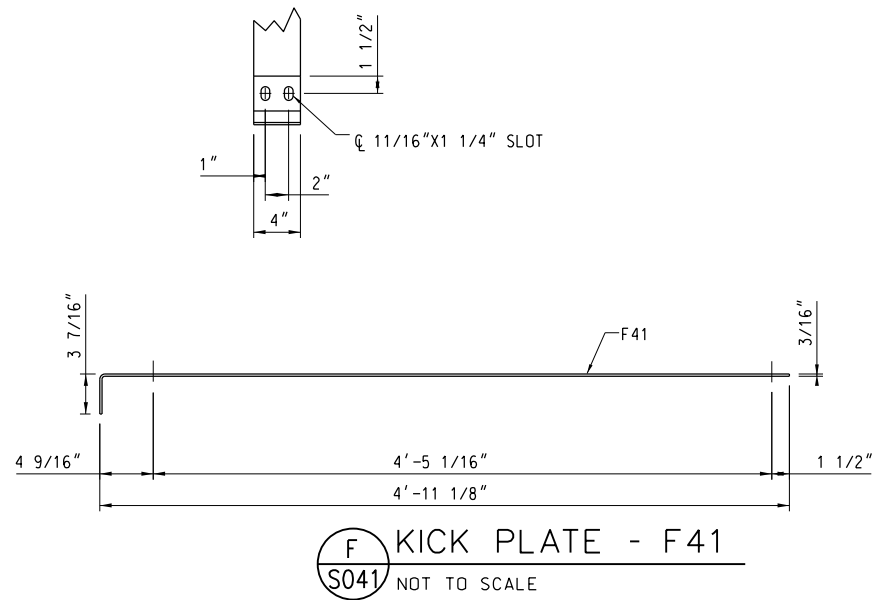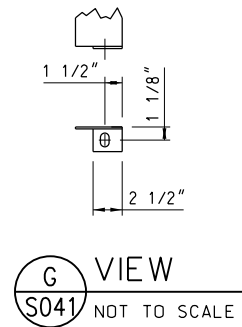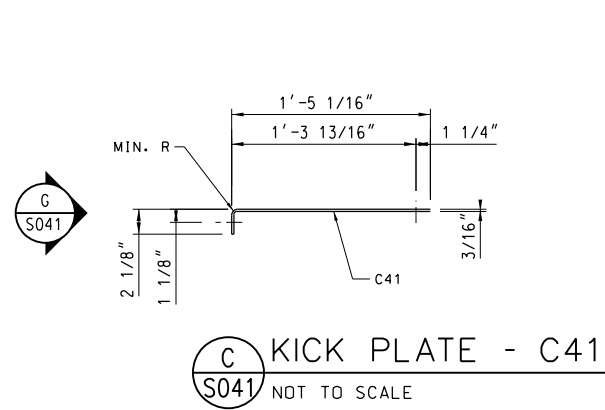


SCALES SHOWN FOR 22" X 34" SHEET. ADJUST SCALES FOR OTHER SIZES.										
<div>HARTRAMPF</div> <div>7000 CENTRAL PARKWAY, SUITE 1475 ATLANTA, GEORGIA 30328</div> <div>HEI JOB NUMBER: 212042.00</div>										
REV	APPROVED DATE	DESCRIPTION					JCN	REDLINE DATE	APVD	
DEPARTMENT OF TRANSPORTATION FEDERAL AVIATION ADMINISTRATION ATO TECHNICAL OPERATIONS EASTERN SERVICE AREA										
ATCBI ATCBI-6 TYPICAL LEVEL GRATING DETAILS										
FREEPORT					BAHAMAS					
REVIEWED BY		SUBMITTED BY				APPROVED BY				
		NEIL BOLEN				STEVE BRADY				
		DESIGNED SNG		ISSUED BY		DATE 4/23/2012		JCN	621767	
		DRAWN SNG		ENGINEERING SERVICES		DRAWING NO				
		CHECKED RAB		SURV/WEATHER		BHF-D-621767- S041		REV		

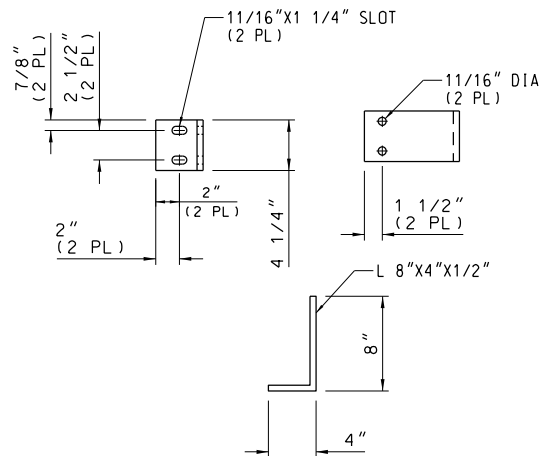


**A** ANGLE AS SHOWN-"A42" (QTY 2)  
S042 NOT TO SCALE

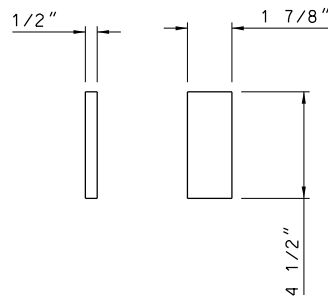


**E** PLATE AS SHOWN-"E42" (QTY 4)  
S042 NOT TO SCALE

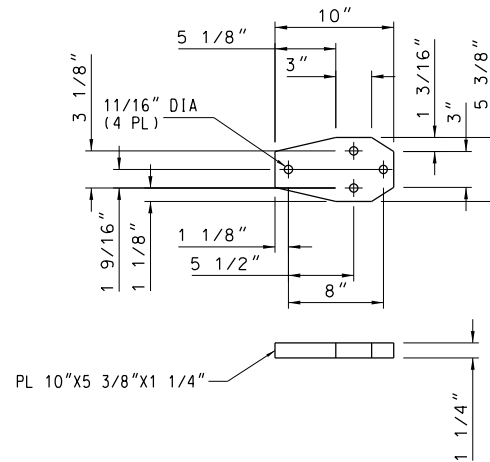

**C** PLATE AS SHOWN-"C42" (QTY 1)  
S042 NOT TO SCALE

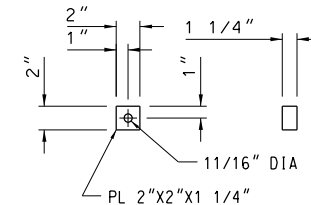











**D** PLATE AS SHOWN-"D42" (QTY 4)  
S042 NOT TO SCALE

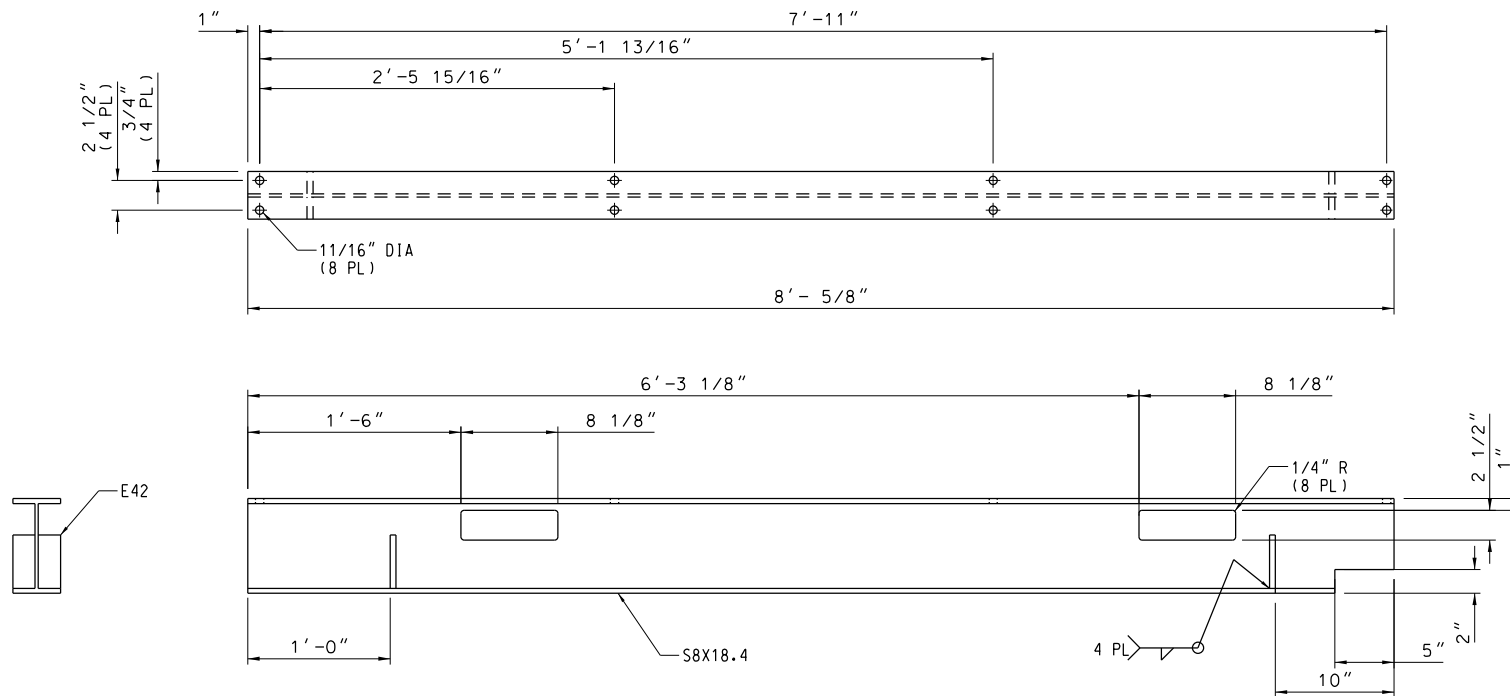



**B** BEAM AS SHOWN-"B42" (QTY 1)  
S042 NOT TO SCALE

SCALES SHOWN FOR 22" X 34" SHEET. ADJUST SCALES FOR OTHER SIZES.									
<div style="display: flex; align-items: center;"> <div style="border: 1px solid black; padding: 5px; margin-right: 10px;"> <b>HARTRAMPF</b> </div> <div> <p>7000 CENTRAL PARKWAY, SUITE 1475 ATLANTA, GEORGIA 30328</p> <p>HEI JOB NUMBER: 212042.00</p> </div> </div>									
REV	APPROVED DATE	DESCRIPTION					JCN	REDLINE DATE	APVD
<div style="display: flex; justify-content: space-between;"> <div> <p>DEPARTMENT OF TRANSPORTATION <b>FEDERAL AVIATION ADMINISTRATION</b> ATO TECHNICAL OPERATIONS</p> </div> <div> <p>EASTERN SERVICE AREA</p> </div> </div>									
<div style="display: flex; justify-content: space-between;"> <div> <p>ATCBI ATCBI-6 MEZZANINE LEVEL HOIST BEAM DETAILS</p> </div> <div> <p>FREEPORT</p> </div> <div> <p>BAHAMAS</p> </div> </div>									
REVIEWED BY		SUBMITTED BY				APPROVED BY			
		NEIL BOLEN				STEVE BRADDY			
		DESIGNED SNG		ISSUED BY		DATE 4/23/2012		JCN 621767	
		DRAWN SNG		ENGINEERING SERVICES		DRAWING NO		REV	
		CHECKED RAB		SURV/WEATHER		BHF-D-621767-S042			




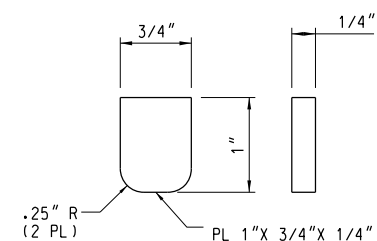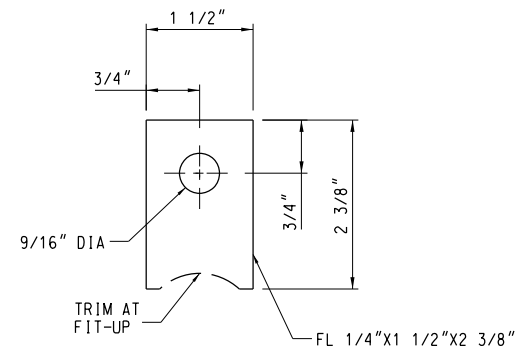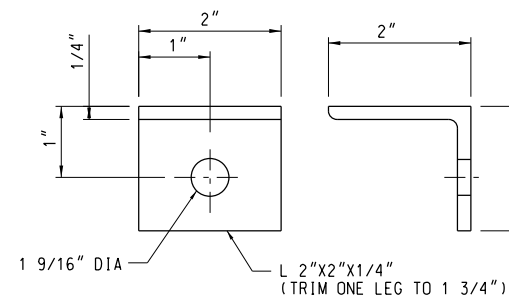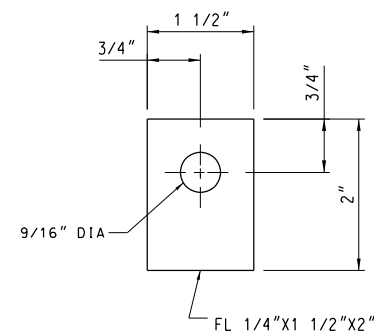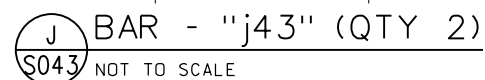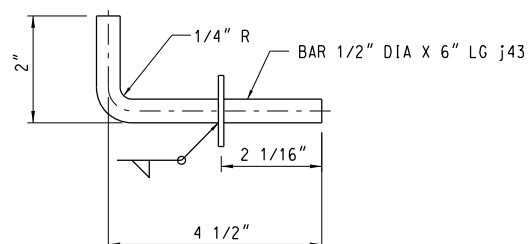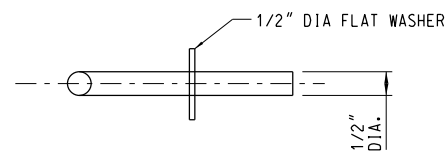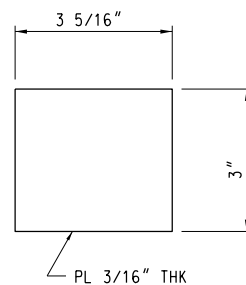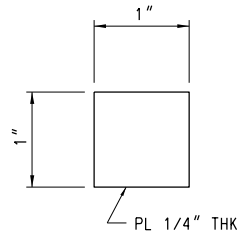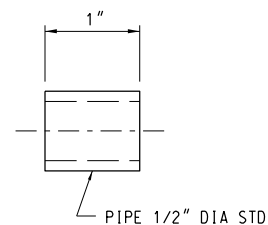


SCALES SHOWN FOR 22" X 34" SHEET. ADJUST SCALES FOR OTHER SIZES.																						
<div><div><div>HARTRAMP</div><div>7000 CENTRAL PARKWAY, SUITE 1475 ATLANTA, GEORGIA 30328</div></div><div>HEI JOB NUMBER: 212042.00</div></div>																						
REV	APPROVED DATE		DESCRIPTION					JCN	REDLINE DATE		AF											
DEPARTMENT OF TRANSPORTATION FEDERAL AVIATION ADMINISTRATION ATO TECHNICAL OPERATIONS												EASTERN SERVICE AREA										
ATCBI ATCBI-6 MEZZANINE LEVEL GATE DETAILS																						
FREEPORT												BAHAMA										
REVIEWED BY		SUBMITTED BY					APPROVED BY															
		NEIL BOLEN					STEVE BRADY															
		DESIGNED		SNG		ISSUED BY		DATE		4/23/2012	JCN	621767										
		DRAWN		SNG		ENGINEERING SERVICES		DRAWING NO		BHF-D-621767-S043												
		CHECKED		RAR		SURV/WEATHER																

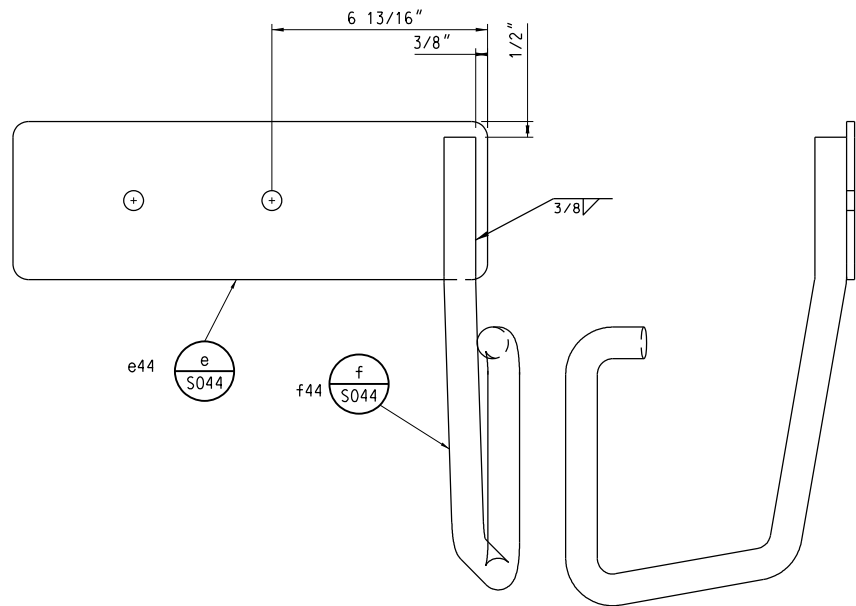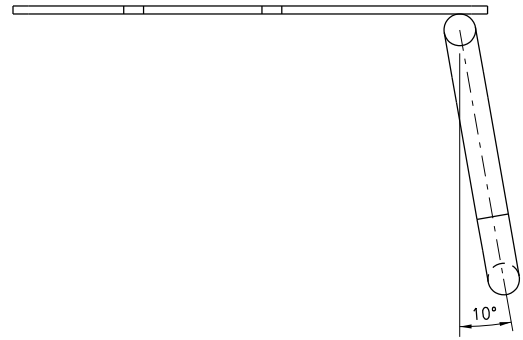


**E** ASSEMBLY - "E44"  
S044 NOT TO SCALE

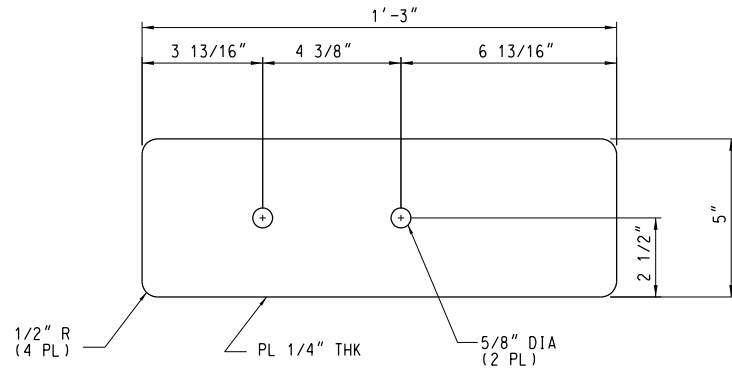

**e** PLATE - "e44" (QTY 1)  
S044 NOT TO SCALE


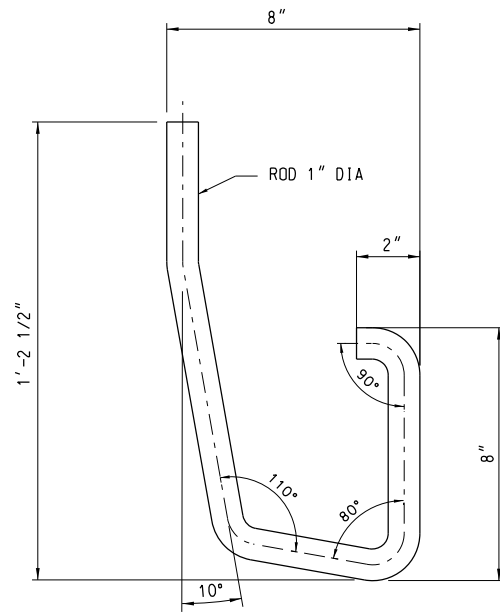


**f** ROD - "f44"  
S044 NOT TO SCALE

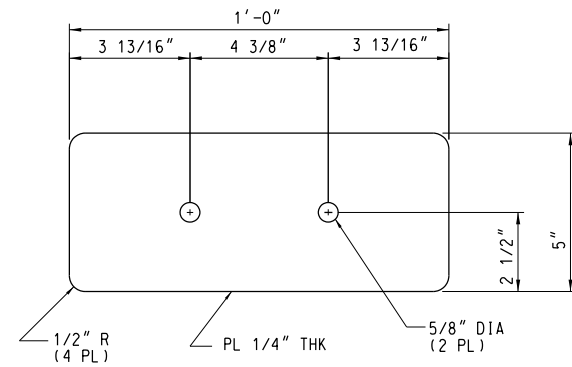


**F** PLATE - "F44" (QTY 1)  
S044 NOT TO SCALE

**FINISH:**  
HOT DIP GALVANIZED

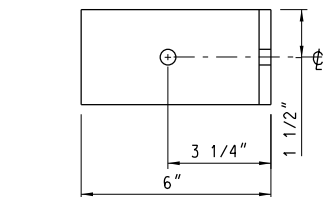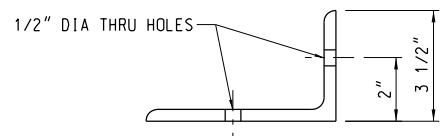


NOTE: THIS IS A CONTRACTOR SUPPLIED ITEM.

**D** BRACKET - "D44" (QTY 2)  
S044 NOT TO SCALE

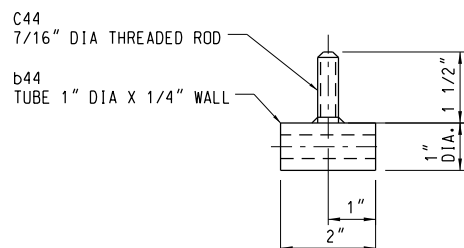

NOTE: THIS IS A CONTRACTOR SUPPLIED ITEM.

**B** ASSY "B44" (QTY 2)  
S044 NOT TO SCALE

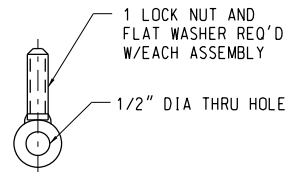


SCALES SHOWN FOR 22" X 34" SHEET. ADJUST SCALES FOR OTHER SIZES.									
7000 CENTRAL PARKWAY, SUITE 1475 ATLANTA, GEORGIA 30328 HEI JOB NUMBER: 212042.00									
DEPARTMENT OF TRANSPORTATION FEDERAL AVIATION ADMINISTRATION ATO TECHNICAL OPERATIONS EASTERN SERVICE AREA									
ATCBI ATCBI-6 TYPICAL HANDRAIL DETAILS									
FREEPORT BAHAMAS									
REVIEWED BY		SUBMITTED BY NEIL BOLEN				APPROVED BY STEVE BRADY			
		DESIGNED SNG		ISSUED BY ENGINEERING SERVICES SURV/WEATHER		DATE 4/23/2012		JCN 621767	
		DRAWN SNG				DRAWING NO		REV	
		CHECKED RAB				BHF-D-621767-S044			

BILL OF MATERIAL						
PCS	DESCRIPTION	LENGTH FT	INS	MARK	REMARKS	WT*3 1/2% GALV.
MAT'L REQ'D FOR ONE 17FT. (TOP) SECTION						
16	1 1/2" J ROD	4	0	A1	GALV.	397.9
16	1 1/2" J CUT WASHER					6.4
32	1 1/2" J HEX NUTS					33.8
4	L 6x6x5/8	2	10 1/8	B1		285.0
4	R 16x1 1/8	1	4	d1		337.0
4	R 19 1/4x1/2	1	7 1/4	b1		123.5
4	R 13 1/2x1/2	1	2 5/8	c1		86.9
4	R 5 3/8x1/2	1	2 5/8	d1		34.6
	1/4" WELD	13	0			3.0
	3/8" WELD	25	0			12.5
4	R 5 1/2x1/2	0	10	e1		
2	5/8" J ROD	1	0	C1	GALV.	2.2
2	5/8" J CUT WASHER					.2
4	5/8" J HEX NUTS					.4
1	L 3x3x3/16	7	9 5/8	A6R		30.4
1	L 3x3x3/16	7	9 5/8	A6L		30.4
1	L 3x3x3/16	7	9 5/8	B6R		30.4
1	L 3x3x3/16	7	9 5/8	B6L		30.4
1	C 6x8.2	24	0	C6		203.7
1	C 6x8.2	24	0	D6		203.7
1	C 6x8.2	24	0	E6		203.7
1	C 6x8.2	24	0	F6		203.7
8	R 4x3/8	0	6	N6		21.1
4	R 20x3/8	1	10 1/4	G6		195.3
4	R 20x3/8	1	10 1/4	H6		146.3
1	R 20x3/8	1	10 1/4	H6g		48.8
8	L 3 1/2x2 1/2x1/4	9	5 5/8	J6R		384.2
8	L 3 1/2x2 1/2x1/4	9	5 5/8	J6L		384.2
1	L 3x2x1/4	7	3 7/8	K6R		62.1
1	L 5x3 1/2x5/16	0	3	b6		4.4
	3/16" WELD	2	0			.3
1	L 3x2x1/4	7	3 7/8	K6L		31.1
1	L 5x3 1/2x5/16	0	3	b6		2.2
	3/16" WELD	1	0			.2
1	L 3x2x1/4	7	3 7/8	M6R		31.1
1	L 5x3 1/2x5/16	0	3	b6		4.4
	3/16" WELD	1	0			.3
1	L 3x2x1/4	7	3 7/8	M6L		62.1
2	L 5x3 1/2x5/16	0	3	b6		4.4
	3/16" WELD	1	0			.3
1	C 6x8.2	9	2 1/2	C7		78.2
1	C 6x8.2	9	2 1/2	F7		78.2
3	R 18 5/8x3/8	1	10 5/8	G7		184.9
6	L 5x3x1/4	0	2 1/4	L7		
1	C 6x8.2	3	10 1/2	H7		32.8
31	L 3x3x1/4	0	4 1/2	J7		41.3
1	L 5x2 1/2x1/4	0	4 1/2	K7	CUT L 5x3x1/4	2.5
1	C 6x8.2	7	10 1/2	M7		66.8
28	L 5x3x1/4	0	4 1/2	N7		73.3
1	C 6x8.2	7	10 3/8	P7		66.7
1	L 5x3x1/4	0	4 1/2	AA7		5.5
1	C 6x8.2	6	10	S7		58.0
1	C 6x8.2	8	10 7/8	T7		75.6
1	C 6x8.2	7	10 1/8	V7R		66.5
1	C 6x8.2	7	10 1/8	V7L		66.5
1	NAME PLATE 2 3/16x5" LONG					
1	C 6x8.2	7	10 1/8	A8		66.5
1	C 6x8.2	7	10 1/8	B8		66.5
3	R 4 1/2x1/4	1	8	J8		19.8
2	L 3x3x3/16	10	7 7/8	K8R		81.8
2	R 4 7/8x1/4	0	7 1/4	b8		5.2
	3/16" WELD	2	0			.3
1	L 3x3x3/16	10	7 7/8	K8L		40.9
1	R 4 7/8x1/4	0	7 1/4	b8		2.6
	3/16" WELD	1	0			.2

BILL OF MATERIAL						
PCS	DESCRIPTION	LENGTH		MARK	REMARKS	WT+3 1/2% GALV.
		FT	INS			
1	L 2x2x3/16	10	11 3/4	M8		27.7
2	L 2x2x3/16	5	4 1/2	N8		27.1
1	R 5 1/4x3/8	0	7 1/4	P8		4.2
1	L 2x2x3/16	10	11 1/8	S8		55.2
1	L 2x2x3/16	5	4 1/8	T8		26.9
1	L 2x2x3/16	5	4 1/8	V8		26.9
1	R 5 1/4x3/8	0	7 1/4	W8		8.4
1	L 2x2x3/16	10	4	AA8		26.1
1	L 2x2x3/16	4	10 3/4	AB8R		12.3
1	L 2x2x3/16	4	10 3/4	AB8L		12.3
1	R 8 1/8x3/8	0	8 3/4	AC8		7.8
1	L 3x3x3/16	9	8 1/4	AD8		37.2
1	HSS 8x3x1/4	23	10	A9		283.6
1	L 2 1/2x2 1/2x1/4	0	4 3/8	a9		2.7
1	L 2 1/2x2 1/2x1/4	1	11 1/2	b9		21.2
1	L 2 1/2x2 1/2x1/4	0	7 3/4	c9		24.4
	3/16" WELD	6	0			.9
	1/8" WELD	17	0			1.4
2	L 2X2X1/4	0	7 3/4	d9		
1	HSS 8x3x1/4	23	10	B9		283.6
1	L 2 1/2x2 1/2x1/4	0	4 3/8	a9		2.7
2	L 2 1/2x2 1/2x1/4	1	11 1/2	b9		21.2
6	L 2 1/2x2 1/2x1/4	0	7 3/4	c9		48.8
4	R 2 1/16X3/8	0	7 9/16	e9		48.8
	3/16" WELD	8	0			1.2
	1/8" WELD	25	0			2.0
1	L'S 2 1/2x2 1/2x1/4	0	2 1/2	g9		1.8
1	HSS 8X3X1/4	23	10	C9R		283.6
1	HSS 8X3X1/4	23	10	C9L		283.6
4	L 6x4x1/2	2	9 5/8	D9		187.8
16	L 2 1/2x2x1/4	10	1	E9		604.3
8	L 2 1/2x2x1/4	10	3 3/8	F9		308.1
16	L 2 1/2x2x1/4	5	0	G9		299.7
8	L 3X3X1/4	7	5	H9R		389.2
8	L 3X3X1/4	7	5	H9L		389.2
4	R 10 3/8x3/8	0	10 3/8	J9		47.2
1	L 2 1/2x2x1/4	5	10	K9R		27.8
1	L 2 1/2x2x1/4	5	10	K9L		27.8
1	L 2 1/2x2x1/4	7	5	H9a		27.8
2	C 8X11.5	23	11 1/4	A10		406.4
4	R 5 1/4x3/8	0	8	a10		13.8
	3/16" WELD	5	0			.8
4	L 5X5X5/16	17	0	B10		134.9
2	R 5 1/4x3/8	0	6	a10		6.9
1	R 6X1/2	2	7	b10		
	3/16" WELD	3	0			.5
1	C 8X11.5	7	10 3/4	F10R		68.3
3	L 2 1/2x2 1/2x1/4	2	0	d10R		5.2
	3/16" WELD	1	0			.2
1	C 8X11.5	7	10 3/4	F10L		68.3
3	L 2 1/2x2 1/2x1/4	2	0	d10L		5.2
	3/16" WELD	1	0			.2
1	C 8X11.5	8	10 7/8	G10L		226.6
2	C 8X11.5	8	10 7/8	G10R		226.6
2	C 8X11.5	5	10 1/8	M10L		99.1
2	C 8X11.5	6	6	M10R		
8	L 2 1/2X2X1/4	7	9 1/8	T10		66.8
						66.6
1	C 8X11.5	7	11 5/16	A11		66.6
1	C 8X11.5	7	11 5/16	B11		66.6
1	C 8X11.5	7	11 1/16	AE11R		
1	C 8X11.5	7	11 1/16	AE11L		

BILL OF MATERIAL						
PCS	DESCRIPTION	LENGTH		MARK	REMARKS	WT*3 1/2% GALV.
		FT	INS			
1	L 3 1/2x3 1/2x1/4	9	8	E1R		108.0
1	R 4 7/8x3/8	0	8	d11		8.6
2	R 5 1/4x3/8	0	5 7/8	e11		6.8
	3/16" WELD	4	0			.6
2	L 3 1/2x3 1/2x1/4	9	8	E11L		54.0
1	R 4 7/8x3/8	0	8	d11		4.5
1	R 5 1/4x3/8	0	5 7/8	e11		3.4
	3/16" WELD	2	0			.3
1	L 2x2x3/16	11	1	F11L		28.0
1	L 2x2x3/16	11	1	F11R		28.0
2	L 2x2x3/16	5	2	G11		26.1
2	L 2x2x3/16	5	5	H11		27.4
1	L 2x2x3/16	9	0 3/8	J11		45.6
2	L 2x2x3/16	4	4	K11R		21.9
2	L 2x2x3/16	4	4	K11L		21.9
1	R 5 3/8x3/16	0	10 1/4	M11		6.1
2	R 6 1/2x3/16	0	7 5/8	N11		5.4
6	L 3x2 1/2x1/4	10	11/4	P11		376.5
2	L 2 1/2x2x1/4	7	7 3/8	S11AR		54.6
2	L 2 1/2x2x1/4	7	7 3/8	S11AR		54.6
3	R 16x3/8	1	4 1/4	V11		114.4
4	R 10 1/2x3/8	1	0 5/8	W11		58.2
2	R 12 7/8x3/8	1	1	AA11		36.9
8	P 13 7/8x3/8	1	4 3/4	AB11		204.1
4	R 10 7/8x3/8	1	1 3/4	AC11		65.4
4	R 12 1/4x3/8	1	0 1/2	AD11		67.3
4	L 4x4x5/16	13	1	A12		444.0
8	R 6x3/8	2	7	a12		163.4
	1/4" WELD	21	0			5.3
1	ANTENNA SUPPORT PLATFORM					
2	W10x60	7	11 3/4	B12		
	W10x45			A12		
2	W10x45	3	8 5/8	J12		
				N12		
		7	11 3/4	b12		991.1
2	L'S 6x6x3/8	0	5 1/2	c12		47.6
1	W 10x45	4	1 1/2	D12		191.9
1	W 10x54	4	1 1/2	E12		230.3
1	R 4 3/4x3/8	0	8 7/8	f12		9.3
1	C 10x15.3	2	2	g12		34.4
1	L 3x3x5/16	0	5 1/2	h12		2.9
1	R 3 3/4x3/8	0	8 7/8	K12		14.6
2	R 7 1/2x1/2	0	8 5/8	m12		19.1
1	R 48x1/4	8	8 3/8	n12		367.4
22	1/2" FLAT HEAD MB	0	1 3/4	W/HEX HD & HEX NUTS		4.2
22	GALV. CUT WASHER 1/2"					.8
22	GALV. PALNUTS 1/2"					.2
	1/4" WELD	101	0			25.3
2	CHK'D P 26x1/4	8	8 3/8	C12		438.6
				P13P		
4	R 1/2X2	0	7 1/2	b13		8.3
4	R 1/2X2	0	7	C13		121.2
4	L2X2X3/16	0	11/2	e13-P		
	1/8" WELD	3	0			.2
	FL 3/16X4	0	8 1/8	X13		
	FL 3/16X4	0	9	Y13		
4	L 4X4X1/4			d13		

SCALE:




7000 CENT  
ATLANTA, GA

[illegible]

CONTINUED ON DWG. BHF-D-621767-S047

TOTAL WEIGHT THIS SHEET 00,000.0


SCALES SHOWN FOR 22" X 34" SHEET. ADJUST SCALES FOR OTHER SIZES.										
										
REV	APPROVED DATE	DESCRIPTION				JCN	REDLINE DATE	APVD		
DEPARTMENT OF TRANSPORTATION <b>FEDERAL AVIATION ADMINISTRATION</b> ATO TECHNICAL OPERATIONS      EASTERN SERVICE AREA										
7000 CENTRAL PARKWAY, SUITE 1475 ATLANTA, GEORGIA 30328  HEI JOB NUMBER: 212042.00			ATCBI ATCBI-6 MATERIAL SCHEDULE							
			FREEPORT      BAHAMAS							
			REVIEWED BY	SUBMITTED BY				APPROVED BY		
				NEIL BOLEN				STEVE BRADY		
		DESIGNED	SNC	ISSUED BY		DATE	4/23/2012	JCN	621767	
		DRAWN	SNC	ENGINEERING SERVICES		DRAWING NO			REV	
		CHECKED	RAB	SURV/WEATHER		BHF-D-621767-S045				

BILL OF MATERIAL						
PCS	DESCRIPTION	LENGTH		MARK	REMARKS	WT+3 1/2% GAL V.
		FT	INS			
CONTINUED FROM DWG SOSD-D-ASR-S040						
				T14-P	PIPE 1 1/4 STD	
	L5X3X5/16			F14		
2	R 1/4X4 1/2X5 1/2 1/8" WELD	0 4	4 1/2 0	N14-P m14	PIPE 1 1/4 STD	0.3
1	R 1/2X2			U14-P		
1	R 1/2x7 1/2 1/8" WELD	0 1	3 0	c13 h14		0.1
1	R 4X3/16 1/8" WELD	2 1	2 1/16 0	Y14		0.1
				W14-P	PIPE 1 1/4 STD	
				X14-P	PIPE 1 1/4 STD	
32	L 3X3X1/4	0	4 3/4	A15L		
32	L 3X3X1/4	0	4 3/4	A15R		
2	L 3X3X1/4	0	6 1/4	B15L		
1	L 3X3X1/4	0	6 1/4	B15R		
3	L 2 1/2x3X1/4	3	11 15/16	C15L		
2	L 2 1/2x3X1/4	3	11 15/16	C15R		
1	L 2 1/2x3X1/4	3	11 9/16	D15L		
1	L 2 1/2x3X1/4	3	11 9/16	D15R		
1	L 2 1/2x3X1/4	3	0	d15		
5	L 2 1/2x3X1/4	3	11 1/4	E15L		
4	L 2 1/2x3X1/4	3	11 1/4	E15R		
1	L 2 1/2x3X1/4	3	9 1/4	F15L		
1	L 2 1/2x3X1/4	3	9 1/4	F15R		
4	L 5X5X5/16	0	4	G15L		
4	L 5X5X5/16	0	4	G15R		
1	L 2 1/2x3X1/4	3	11 1/8	H15L		
1	L 2 1/2x3X1/4	3	11 1/8	H15R		
1	M 8X6.5	7	6 5/8	J15L		
1	M 8X6.5	7	6 5/8	J15R		
1	L 3X3X3/16	7	3 1/2	J15L		
1	L 3X3X3/16	7	3 1/2	J15R		
2	L 4X4X1/4	0	4 1/4	K15L		
2	L 4X4X1/4	0	4 1/4	K15R		
2	L 2 1/2x3X1/4	4	0 1/16	L15		
1	L 2 1/2x3X1/4	3	9 1/4	M15L		
1	L 2 1/2x3X1/4	3	9 1/4	M15R		
1	L 2 1/2x3X1/4	3	0	m15		
1	L 2 1/2x3X1/4	3	11 11/16	N15L		
1	L 2 1/2x3X1/4	3	11 11/16	N15R		
1	L 2 1/2x3X1/4	3	0	n15		
1	C 8x11.5	8	10 7/8	R15		
2	L 2 1/2x3X1/4	0	8	a15		
1	L 2 1/2x2 1/2X1/4	1	10	b15		
1	FL 3/16X2 1/2	0	7	c15		
1	C 8x11.5	10	3 11/16	A16L		
1	L 3x3x1/4	0	11 7/8	a16R		0.9
1	L 3x3x1/4	1	0	b16L		4.3
	1/8" WELD	2	0			0.2
1	C 8x11.5	10	3 11/16	A16R		116.8
1	L 3x3x1/4	0	11 7/8	a16R		0.9
1	L 3x3x1/4	1	0	b16R		4.3
	1/8" WELD	2	0			0.2
1	R 4X3/16	2	4	C16		22.4
9				TR1		
8				TR2		
2				TR4		
1	C 8x11.5	9	1 15/16	A17L		
1	L 5x3x5/16	0	3			
1	L 3x3x1/4	1	0 1/8			
	1/8" FILLET WELD	2	0			
1	C 8x11.5	9	1 15/16	A17R		
1	L 5x3x5/16	0	3			

BILL OF MATERIAL		LENGTH		MARK	REMARKS	WT*3 1/2% GALV.
PCS	DESCRIPTION	FT	INS			
	ONE FRAME			A18		
1	L 1 1/2x1 1/2x1/8	6	4 7/8	a18R		
1	L 1 1/2x1 1/2x1/8	8	5 11/15	b18R		9.2
1	L 1 1/2x1 1/2x1/8	5	8 1/16	c18R		0.6
1	3/4 #9 6T 3/4x78 1/4 1/8" FILLET WELD	11	0	d18R		5.4
	DOOR FRAME			A19		1.2
	L 1 1/2x1 1/2x1/8	6	10	c19		0.9
1	L 1 1/2x1 1/2x1/8	2	4	b19		
1	SCREEN #9 1 1/2x3 1/4	5	5	e19		
1	L 1 1/2x1 1/2x1/8	1	4	w19		
1	L 1 1/2x1 1/2x1/8	1	10	y19		
1	SCREEN #9 21X16	2	4	z19		
4	BAR 2X1/4	0	6	G19		
8	BAR 2X1/4	0	5 1/4	H19		
4	BAR 2X1/4	0	3 9/16	J19		
2	BAR 2X1/4	0	6 7/8	K19		
4	BAR 2X1/4	0	13 5/8	M19		
1	L 2X2X3/16	0	4	P19		
	L 1X1 1/4X3/16			u19		
	R 2X10X3/16			v19		
3	C 6X8.2	3	10 15/16	A20		
1	C 6X8.2	7	10 7/8	B20		
2	L 2 1/2X2 1/2X1/4	0	6	r6		
1	C 6X8.2	9	2 1/2	E20		
1	L 3X3X3/16	7	11 5/8	a20		
1	BAR 3X3/16	7	7 11/16	b20		
4	P 5X5 1/4X1/4			c20		
1	C 6X8.2	9	2 1/2	F20		
1	L 3X3X3/16	7	11 5/8	a20		
1	BAR 3X3/16	7	7 11/16	b20		
4	P 5X5 1/4X1/4			c20		
1	L 2 1/2X2 1/2X1/4	0	6	A21		
1				r6		
				B21		
1	L 2 1/2X2 1/2X1/4	0	6	r6		
				C21		
2	L 2 1/2X2 1/2X1/4	0	6	r6		
				D21		
	L 2 1/2X2 1/2X1/4	0	6	r6		
2				E21		
	L 2 1/2X2 1/2X1/4	0	6	r6		
2	L 2X2X3/16	8	9 1/2	F21		
2	L 3X3X1/4	7	11 5/8	G21		
2	R 3/8X6X3 1/2			a21		
1	L 3X3X1/4			K21		
1	R 3/8X6X3 1/2			a21		
1	L 3X3X1/4			L21		
1	R 3/8X6X3 1/2			a21		
2	L 2X2X3/16	0	5 3/16	H21		
2	L 2X2X3/16	0	5 3/16	J21		
	1 1/4 DIA. STD. PIPE			C22L		
2	FL 1/2X2 1/2	0	10 9/16	b4		
1	FL 1/2X2 1/2	0	9 9/16	b22		
	1 1/4 DIA. STD. PIPE			C22R		
2	FL 1/2X2 1/2	0	10 9/16	b4		
1	FL 1/2X2 1/2	0	9 9/16	b22		
2	C 8x11.5	23	11 1/4	A25		
2	R 5 1/4X3/8	0	8	a25		
1	L 3 1/2X3 1/2X1/4	3	3	B25		
	R 3 11/16X3/8	0	8 7/8	b25		
	R 5 1/2X3/8	0	6 5/8	c25		
2	L 3 1/2X3 1/2X1/4	6	2 7/16	C25		
	R 4 1/2X3/4	0	8 3/8	d25		
1	L 3X2 1/2X1/4	7	3 7/8	A26		
1	L 5X3 1/2X5/16	0	3	a26		
1	C 6X8.2	7	3 7/8	B26		
1	L 5X3 1/2X5/16	0	3	e26		
1	C 6X8.2	7	3 7/8	C26		
1	L 5X3 1/2X5/16	0	3	e26		
1	L 3X2 1/2X1/4	7	3 7/8	D26		
1	L 5X3 1/2X5/16	0	3	a26		
2	L 3X2 1/2X1/4	9	0	G26		
1	R 2 1/2X1/4	0	8	K26		
1	R X3/8			J26		
1	R X3/8			H26		
1	C 6X8.2	7	9 3/4	E26		
3	R 3X1/4	0	3	b26		
1	L 3X3X3/16	7	3 1/2	c26		
1	C 6X8.2	7	9 3/4	F26		
3	R 3X1/4	0	3	b26		
1	L 3X3X3/16	7	3 1/2	c26		

BILL OF MATERIAL		LENGTH		MARK	REMARKS	WT+3 1/27 GALV.
PCS	DESCRIPTION	FT	INS			
	L 2 1/2X3X1/4			K31		
1	R 2X1/4	1	2	LL31		
1	L 5X3X			MM31		
8	R 10X3/8	1	1 1/2	C32		
4	L3X3X1/4	7	6	D32R		
4	L3X3X1/4	7	6	D32L		
2	W8X24 RADII BEAM			A32R		
2	W8X24 RADII BEAM			A32L		
2	R 7X1/2	0	7 15/16	d32		
				A33		
	L1X1X1/8	6	3 9/16	d33R		
	L1X2X1/8	1	10 3/8	c33		
	L1X1X1/8	1	10 3/8	b33		
	L1X1X1/8	2	7 1/2	d33		
	L1X1X1/8	1	10 1/4	e33		
1	R			m33		
1				P34-P		
2	FL 1/2X2 1/2	0	7 1/2	d34-P		
5				c13		
	CHECKERED PLATE			A36		
	CHECKERED PLATE			B36		
	CHECKERED PLATE			C36		
	CHECKERED PLATE			D36		
	CHECKERED PLATE			E36		
	CHECKERED PLATE			F36		
	L 3X3X1/4			d36		
1	L 3X3X1/4			B36		
	L 2X2X1/4			c36		
2	R 7/8X5/16	0	2	E36		
1	L 3X3X1/4			A36R		
1	L 3X3X1/4			A36L		
				A37		
1	L 5X3X1/4	7	2 5/16	d37		
1	L 5X3X1/4	7	2 5/16	b37		
1	L 5X3X1/4	5	4	c37		
1	L 1 1/2X1 1/2X1/4		79 3/4	p37		
				B37		
2	L 2X2X1/8	2	2 1/2	d37		
2	L 2X2X1/8	2	8	e37		
				E37		
1	R 2X2 1/2X1/8	3	0	K37		
				m37		
				n37		
4	R 2 1/2X3/16	0	6 1/2	D37		
1	EQUIPMENT SHELTER			A38		
2		10	0	A39		
2		17	0	A39		
2		3	0 1/2	B39		
2		5	7 7/8	C39		
1	L2X2X3/16	0	8	D39L		
1	L2X2X3/16	0	8	D39R		
2	R 3/16X 4 13/16	1	0	E39		
				C41		
				F41		
				W41		
				H34		
				x41		
				y41		
2	L8X4X1/2			A42		
4	R 1 7/8X1/2	0	4 1/2	E42		
1	R 10X5 3/8X1 1/4			C42		
4	R 2X2X1 1/4			D42		
1	S 8X18.4			B42		
	GATE			A43		
	FL 1/4X1 1/2X2			U43		
	L2X2X1/4			h43		
	FL 1/4X1 1/2X2 3/8			T43		
	R 1X3/4X1/4			K43		
	ROD 1/2 DIA.			P43		
	PIPE 1/2 DIA.	0	1	O43		
	R 1X1X1/4			R42		
	R 3 5/8X3X3/16			S42		
2	BAR 1/2 DIA. 2X4 1/2			j43		
					</	

TOTAL WEIGHT FOR THIS SHEET 9450.4  
TOTAL WEIGHT FOR ONE 17FT. TOP SECTION 27,269.9

SCALES SHOWN FOR 22" X 34" SHEET. ADJUST SCALES FOR OTHER SIZES.									
									
REV	APPROVED DATE	DESCRIPTION				JCN	REDLINE DATE	APVD	
7000 CENTRAL PARKWAY, SUITE 1475 ATLANTA, GEORGIA 30328 HEIJOB NUMBER: 212042.00		DEPARTMENT OF TRANSPORTATION <b>FEDERAL AVIATION ADMINISTRATION</b> ATO TECHNICAL OPERATIONS EASTERN SERVICE AREA							
		ATCBI ATCBI-6 MATERIAL SCHEDULE							
		FREEPORT				BAHAMAS			
REVIEWED BY	SUBMITTED BY				APPROVED BY				
	NEIL BOLEN				STEVE BRADY				
		DESIGNED	SNG	ISSUED BY	DATE	4/23/2012	JCN	621767	
		CHECKED	SNG	ENGINEERING SERVICES	DRAWING NO				
		CHECKED	RAB	SURV/WEATHER	BHF-D-621767-S046				REV

NOTES:

1. ALL HARDWARE 1/2" DIAMETER OR LARGER SHALL BE TORQUED AT FINAL ASSEMBLY USING "TURN-OF-THE-NUT" METHOD IN ACCORDANCE WITH AISC GUIDELINES.
- SUMMARY - PRIOR TO TORQUING, ALL BOLTS SHALL BE BROUGHT INTO A "SNUG TIGHT" CONDITION. SNUG TIGHT IS DEFINED AS THE TIGHTNESS OBTAINED BY A FEW IMPACTS OF AN IMPACT WRENCH OR THE FULL EFFORT OF A MAN USING AN ORDINARY SPUD WRENCH. PARTS OF A JOINT SHOULD BE IN GOOD CONTACT WITH EACH OTHER.
- ALL 5/8" OR 3/4" DIAMETER BOLTS SHALL BE TIGHTENED ADDITIONALLY BY ROTATING THE NUT RELATIVE TO THE BOLT BY 1/3 OF A TURN, PLUS OR MINUS 30°.
- HARDWARE THAT IS TORQUED AND THEN LOOSENED SHALL NOT BE RE-USED.
2. USE SHIMS BETWEEN PEDESTAL ADAPTER AND THE TOWER SUPPORTING STRUCTURE TO OBTAIN A LEVEL CONDITION +/- .20° RELATIVE TO THE PEDESTAL INTERFACE PADS.

AR	27	07957		ZINC RICH COATING		ZINC PRODUCTS CO.
4	26		McMASTER #91654A146	DRIVE SCREW, #6 X 3/8" LG.		STAINLESS
1	25	19564	123589	NAME PLATE		CRSI
1	24	19564	123592-301	RADOME KIT		CRSI
REF	23	19564	123609	INTERFACE CONTROL DRAWING		
-	22	19564	123588-116	LIGHTNING PROTECTION KIT		
-	21	19564	123588-115	LIGHTNING PROTECTION KIT		
-	20	19564	123588-114	LIGHTNING PROTECTION KIT		
1	19	19564	123588-113	LIGHTNING PROTECTION KIT		
-	18	19564	123588-112	LIGHTNING PROTECTION KIT		
-	17	19564	123588-111	LIGHTNING PROTECTION KIT		
-	16	19564	123588-110	LIGHTNING PROTECTION KIT		
-	15	19564	123588-109	LIGHTNING PROTECTION KIT		
-	14	19564	123588-108	LIGHTNING PROTECTION KIT		
-	13	19564	123588-107	LIGHTNING PROTECTION KIT		
-	12	19564	123588-106	LIGHTNING PROTECTION KIT		
-	11	19564	123588-105	LIGHTNING PROTECTION KIT		
-	10	19564	123588-104	LIGHTNING PROTECTION KIT		
-	9	19564	123588-103	LIGHTNING PROTECTION KIT		
-	8	19564	123588-102	LIGHTNING PROTECTION KIT		
-	7	19564	123588-101	LIGHTNING PROTECTION KIT		
1	6	19564	123591-302	17' SECTION WITH RADOME		
-	5	19564	123591-301	17' SECTION		
1	4	19564	123581-304	10' SECTION, SUB-MEZZANINE		
2	3	19564	123581-303	10' SECTION, MID-LEVEL		
1	2	19564	123581-302	10' SECTION, STANDARD, GROUND		
-	1	19564	123581-301	10' SECTION, HEAVY, GROUND		CRSI
-313 57' TWR	ITEM NO.	CAGE NO.	PART NO. OR IDENT NO.	DESCRIPTION	MATERIAL	SPECIFICATION OR MANUFACTURER
PARTS LIST						

REPLACEMENT MEMBER SCHEDULE

PIECE	SIZE	QTY	SHEET #
D2	L4X4X1/4 (L4X4X3/8 @ 40'-0" LEVEL)	4	S002
E2	L4X4X1/4 (L4X4X3/8 @ 40'-0" LEVEL)	4	S002
M8	L2-1/2X2-1/2X3/16	1	S008
N8	L2-1/2X2-1/2X3/16	2	S008
S8	L2-1/2X2-1/2X3/16	1	S008
T8	L2-1/2X2-1/2X3/16	1	S008
V8	L2-1/2X2-1/2X3/16	1	S008
B9	HSS8X3X1/4	1	S009
C9R	HSS8X3X1/4	1	S009
C9L	HSS8X3X1/4	1	S009
M10R	C8X11.5	1	S010
B10	L5X5X1/2 (L5X5X5/16-TOP 17'-0")	4	S010
AB11	PL13 7/8" X 3/8" X 1'- 4 3/4"	8	S011
AC11	PL10 7/8" X 3/8" X 1'- 1 3/4"	4	S011
AD11	PL12 1/4" X 3/8" X 1'- 0 1/2"	4	S011
A20	C6X8.2	2	S020
	CHECKERED PLATES TO BE REPLACED		
E23	3/8" THICK CHECKERED PLATE	1	S023
F23	3/8" THICK CHECKERED PLATE	1	S023

\* NOTATIONS IN THIS SCHEDULE AND PIECE MARKS ON DRAWINGS S045 AND S046 DOES NOT ALLEVIATE CONTRACTOR'S REVIEW OF ALL CONTRACT DRAWINGS TO ENSURE NO ADDITIONAL MEMBERS NEED TO BE MODIFIED/REPLACED.

- △ ORDER FOR FIELD RETROFIT ONLY.
- △ DURING ASSEMBLY, APPLY ZINC RICH COATING WITH BRUSH OR DAUBER, IN ACCORDANCE WITH MANUFACTURERS INSTRUCTIONS TO ALL SCRATCHES, NICKS, CUTS, FIELD DRILLED HOLES, OR ANY OTHER BARE STEEL SURFACES.

SCALES SHOWN FOR 22" X 34" SHEET. ADJUST SCALES FOR OTHER SIZES.

HARTRAMPF

7000 CENTRAL PARKWAY, SUITE 1475  
ATLANTA, GEORGIA 30328

HEI JOB NUMBER: 212042.00

REV	APPROVED DATE	DESCRIPTION	JCN	REDLINE DATE	APVD

DEPARTMENT OF TRANSPORTATION  
FEDERAL AVIATION ADMINISTRATION  
ATO TECHNICAL OPERATIONS EASTERN SERVICE AREA

ATCBI  
ATCBI-6  
SCHEDULE  
ATCBI TOWER LIST


FREEPORT

BAHAMAS


REVIEWED BY	SUBMITTED BY	APPROVED BY
	NEIL BOLEN	STEVE BRADDY
	DESIGNED SNG	ISSUED BY
	DRAWN SNG	ENGINEERING SERVICES
	CHECKED RAB	SURV/WEATHER

DATE 4/23/2012	JCN 621767
DRAWING NO BHF-D-621767-S101	REV


CONTRACTOR RESPONSIBLE  
FOR FALL PROTECTION  
UNTIL RADOME IS PLACED

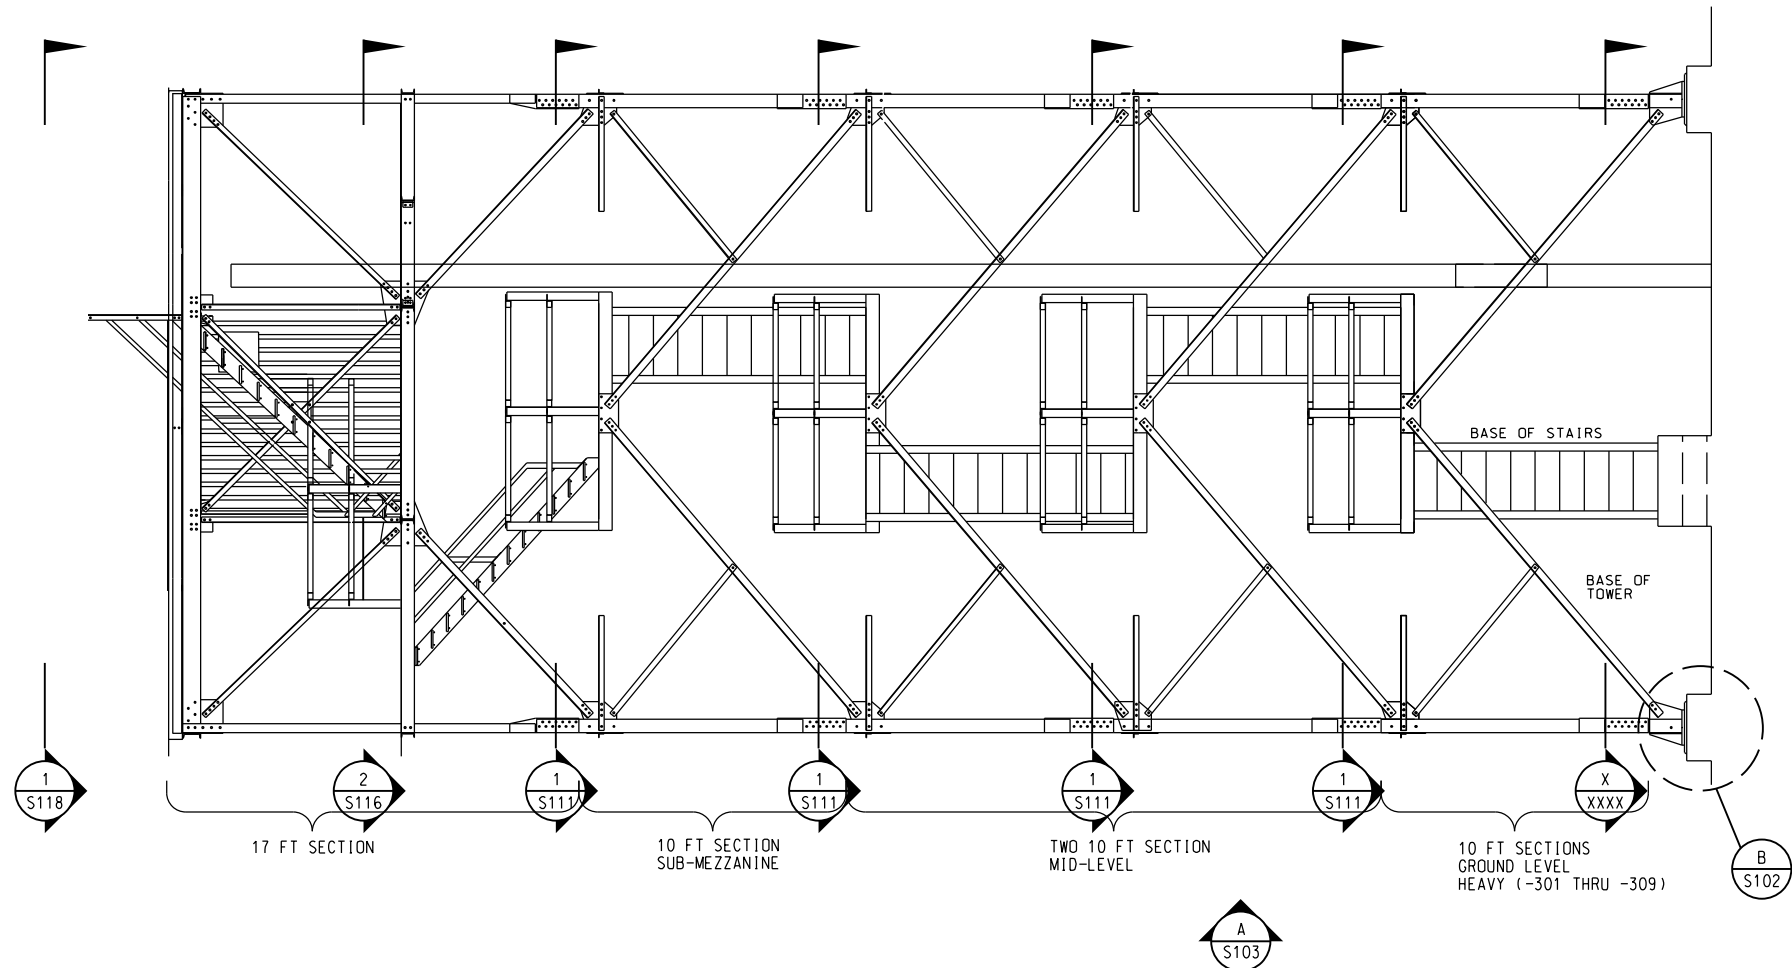


1 TOWER WITH RADOME (NOT SHOWN)  
S102 NOT TO SCALE

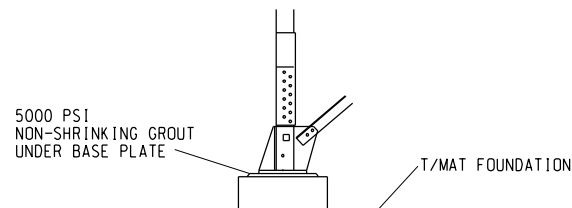


B VIEW  
S102 NOT TO SCALE  
ROTATED 90° CW

SCALES SHOWN FOR 22" X 34" SHEET. ADJUST SCALES FOR OTHER SIZES.									
									
7000 CENTRAL PARKWAY, SUITE 1475 ATLANTA, GEORGIA 30328 HEI JOB NUMBER: 212042.00									
DEPARTMENT OF TRANSPORTATION FEDERAL AVIATION ADMINISTRATION ATO TECHNICAL OPERATIONS EASTERN SERVICE AREA									
ATCBI ATCBI-6 TOWER ELEVATION									
FREEPORT BAHAMAS									
REVIEWED BY		SUBMITTED BY NEIL BOLEN				APPROVED BY STEVE BRADY			
		DESIGNED SNG		ISSUED BY ENGINEERING SERVICES SURV/WEATHER		DATE 4/23/2012		JCN 621767	
		DRAWN SNG				DRAWING NO BHF-D-621767-S102		REV	
		CHECKED RAB							




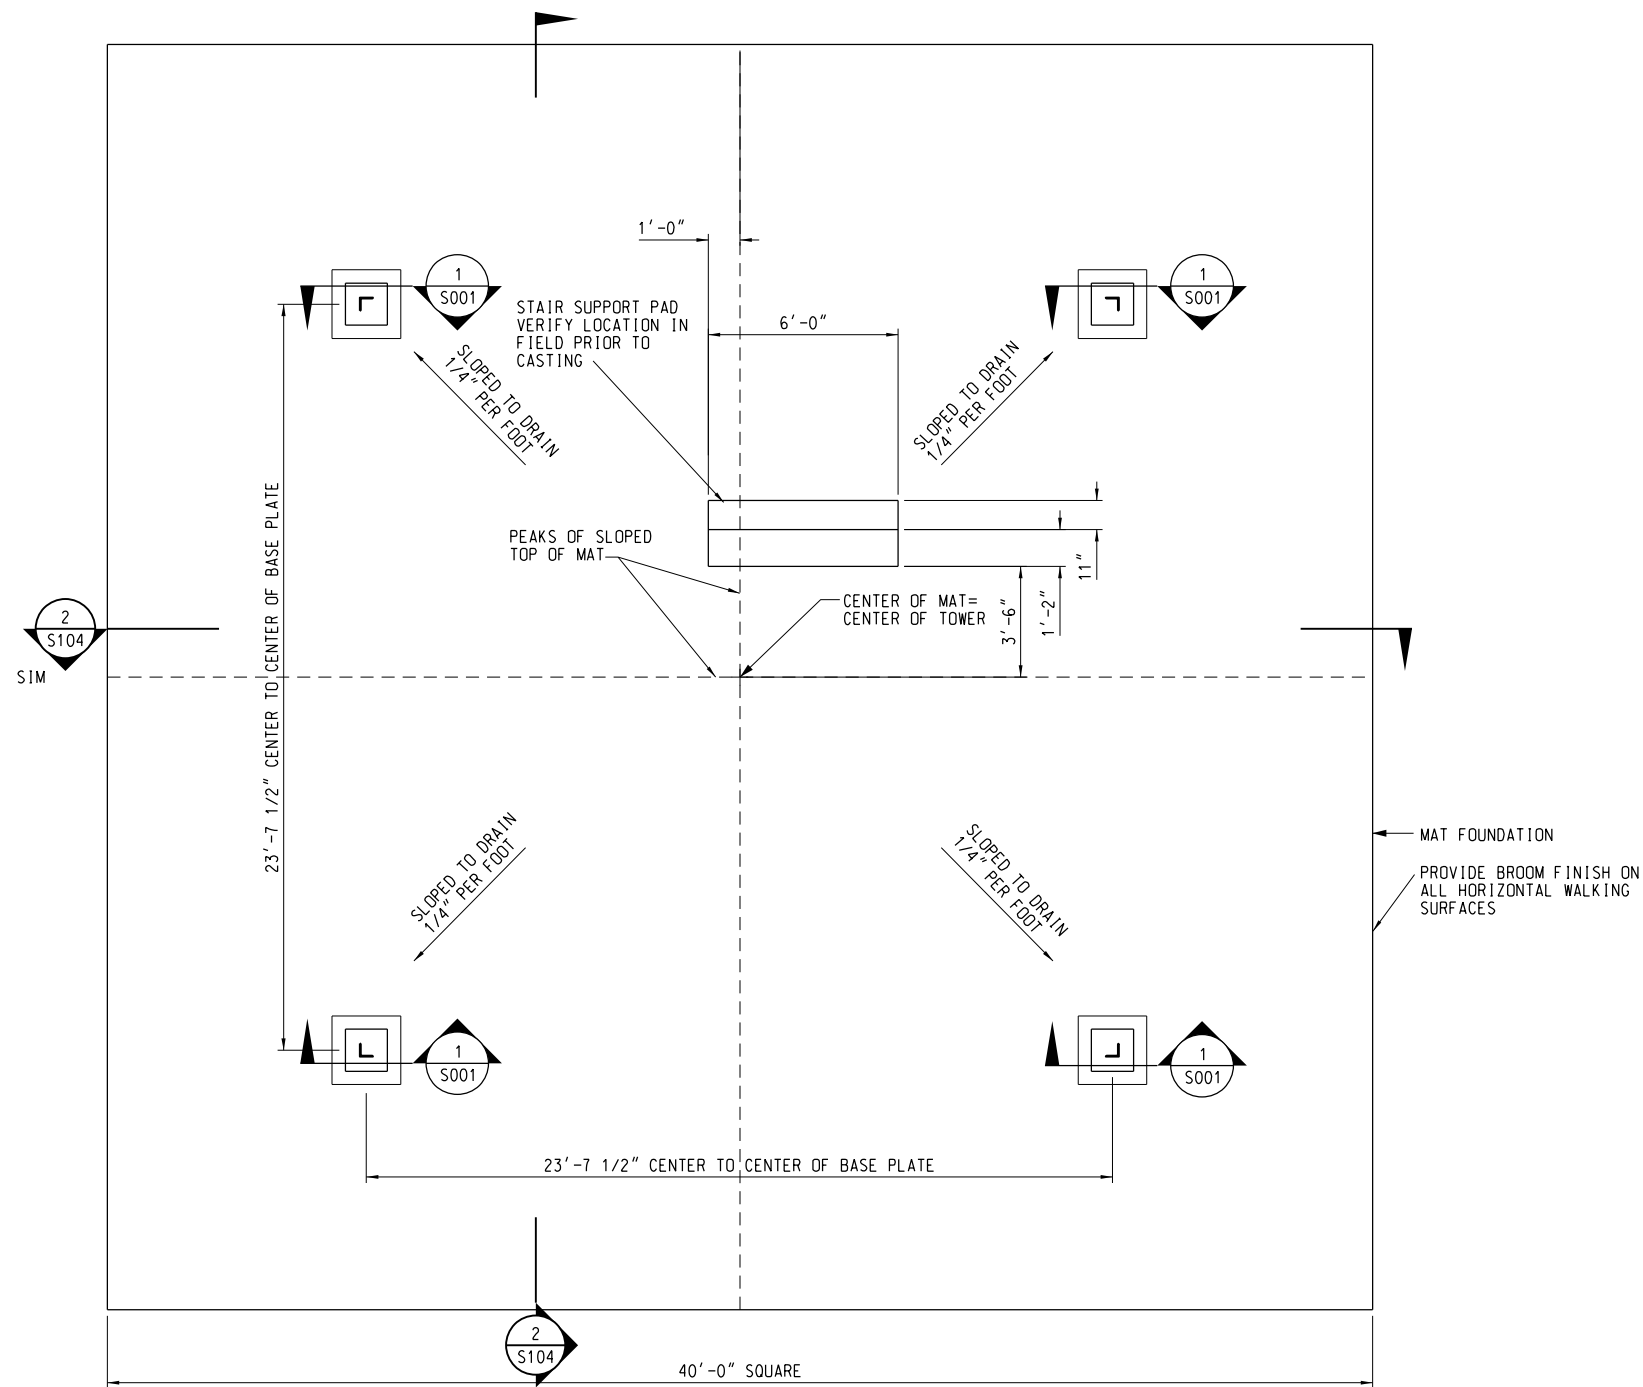

1 ATCBI TOWER FOUNDATION PLAN  
S104 NOT TO SCALE

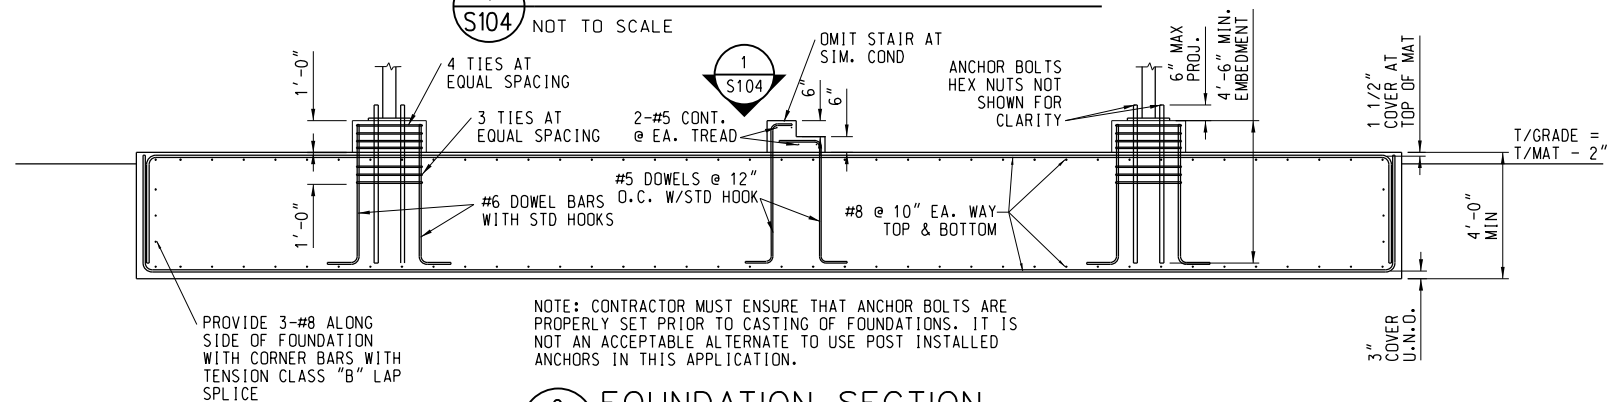


2 FOUNDATION SECTION  
S104 NOT TO SCALE

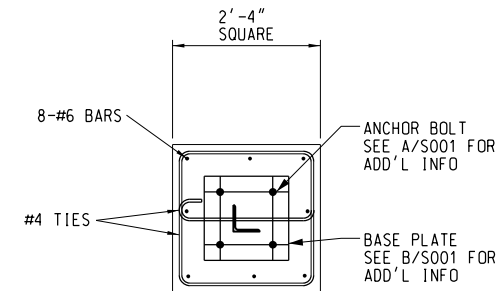

2 ANCHOR BOLT LAYOUT  
S104 NOT TO SCALE


## NOTES

1. ALL STEEL HAS BEEN FABRICATED WITH THE EXCEPTION OF THOSE MEMBERS NOTED "REPLACEMENT MEMBERS" ON PIECE SHEETS. CONTRACTOR IS RESPONSIBLE FOR VERIFYING ALL PIECES PRIOR TO THE START OF STEEL PLACEMENT.
2. INITIAL GEOTECHNICAL RECOMMENDATIONS INDICATE THAT A LARGE MAT FOUR FEET BELOW EXISTING SUBSURFACE WILL BE ABLE TO WITHSTAND APPLICABLE LOADINGS.


SCALES SHOWN FOR 22" X 34" SHEET. ADJUST SCALES FOR OTHER SIZES.									
<div><p>7000 CENTRAL PARKWAY, SUITE 1475 ATLANTA, GEORGIA 30328 HEI JOB NUMBER: 212042.00</p></div>									
DEPARTMENT OF TRANSPORTATION FEDERAL AVIATION ADMINISTRATION ATO TECHNICAL OPERATIONS EASTERN SERVICE AREA									
ATCBI ATCBI-6 TOWER FOUNDATION PLAN									
FREEPORT, BAHAMAS									
REVIEWED BY		SUBMITTED BY NEIL BOLEN			APPROVED BY STEVE BRADY				
		DESIGNED SNG			ISSUED BY ENGINEERING SERVICES SURV/WEATHER		DATE 4/23/2012		JCN 621767
		DRAWN SNG					DRAWING NO		REV
		CHECKED RAB					BHF-D-621767-S104		



CONTRACTOR TO COORDINATE SHELTER DIMENSIONS WITH THAT PROVIDED AND ALIGN OUTSIDE FACE OF FOUNDATION WITH OUTSIDE FACE OF TURNDOWN PER SHELTER FABRICATION DRAWINGS

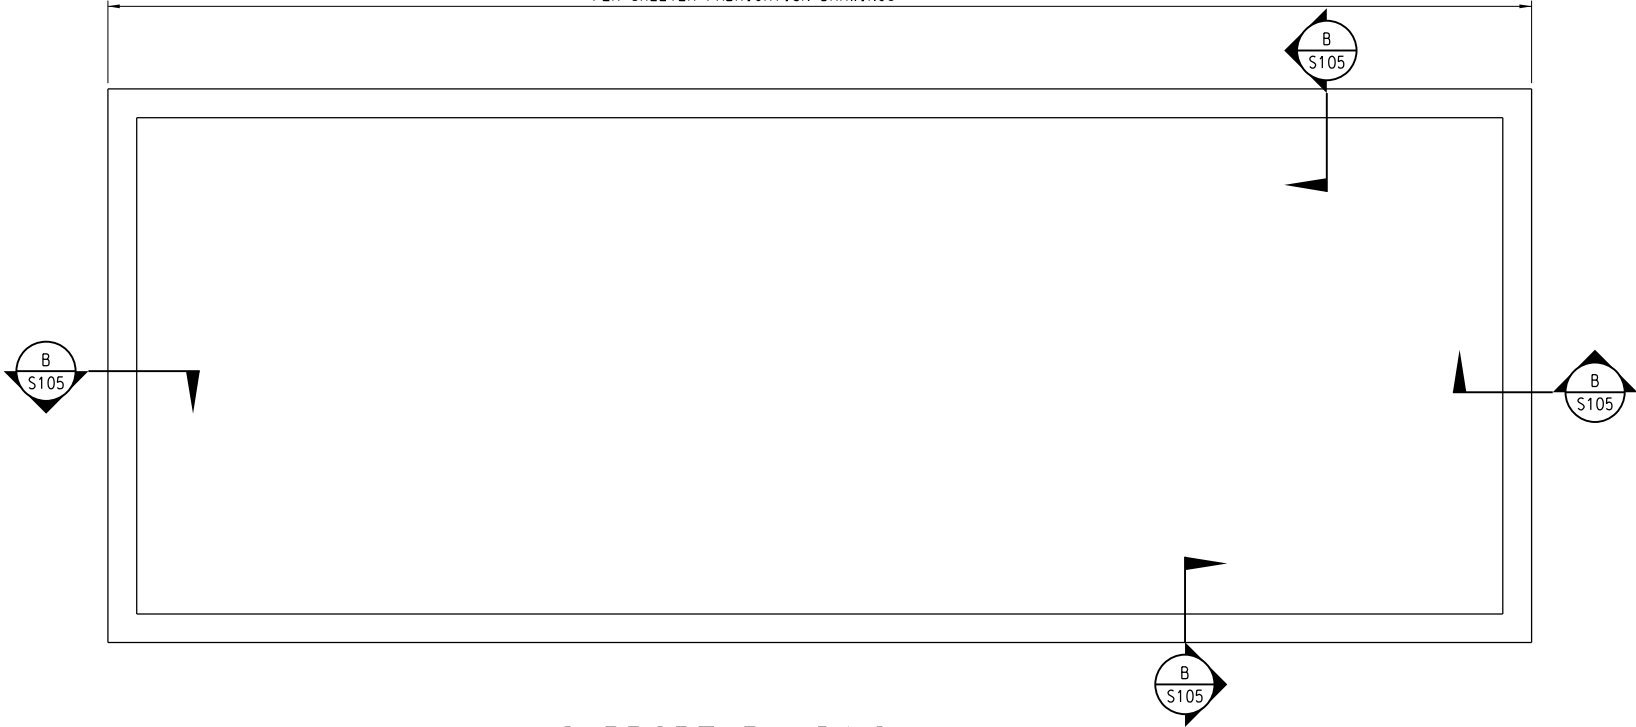


**A**  
**S105** SUPPORT BUILDING FOUNDATION PLAN  
SCALE: 1/2" = 1'-0"

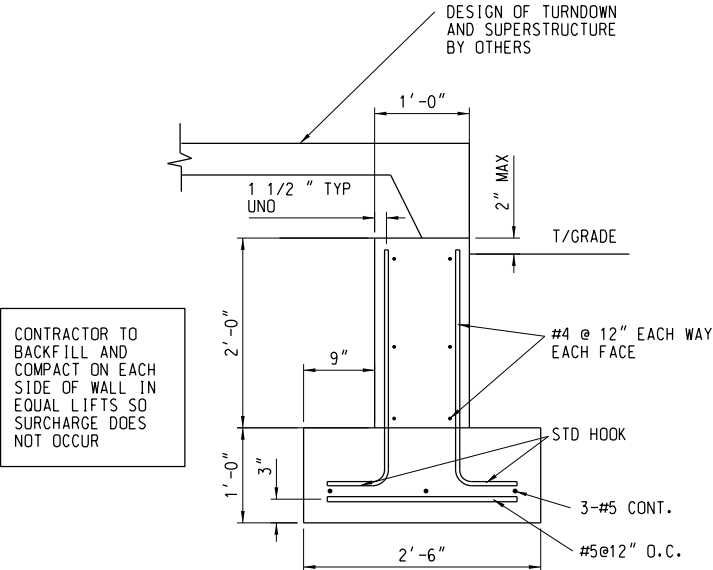


**B**  
**S105** FOUNDATION SECTION  
SCALE: 1" = 1'-0"

CONTRACTOR TO BACKFILL AND COMPACT ON EACH SIDE OF WALL IN EQUAL LIFTS SO SURCHARGE DOES NOT OCCUR

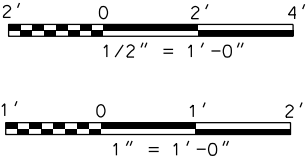

SCALES SHOWN FOR 22" X 34" SHEET. ADJUST SCALES FOR OTHER SIZES.										
<div><div>HARTRAMPF</div><div>7000 CENTRAL PARKWAY, SUITE 1475 ATLANTA, GEORGIA 30328</div></div> <div>HEI JOB NUMBER: 212042.00</div>										
REV	APPROVED DATE	DESCRIPTION				JCN	REDLINE DATE	APVD		
DEPARTMENT OF TRANSPORTATION FEDERAL AVIATION ADMINISTRATION ATO TECHNICAL OPERATIONS EASTERN SERVICE AREA										
ATCBI ATCBI-6 SUPPORT BUILDING FOUNDATION PLAN										
FREEPORT						BAHAMAS				
REVIEWED BY		SUBMITTED BY				APPROVED BY				
		NEIL BOLEN				STEVE BRADDY				
		DESIGNED SNG		ISSUED BY		DATE	4/23/2012	JCN	621767	
		DRAWN SNG		ENGINEERING SERVICES		DRAWING NO				
		CHECKED RAB		SURV/WEATHER		BHF-D-621767- S105				
						REV				

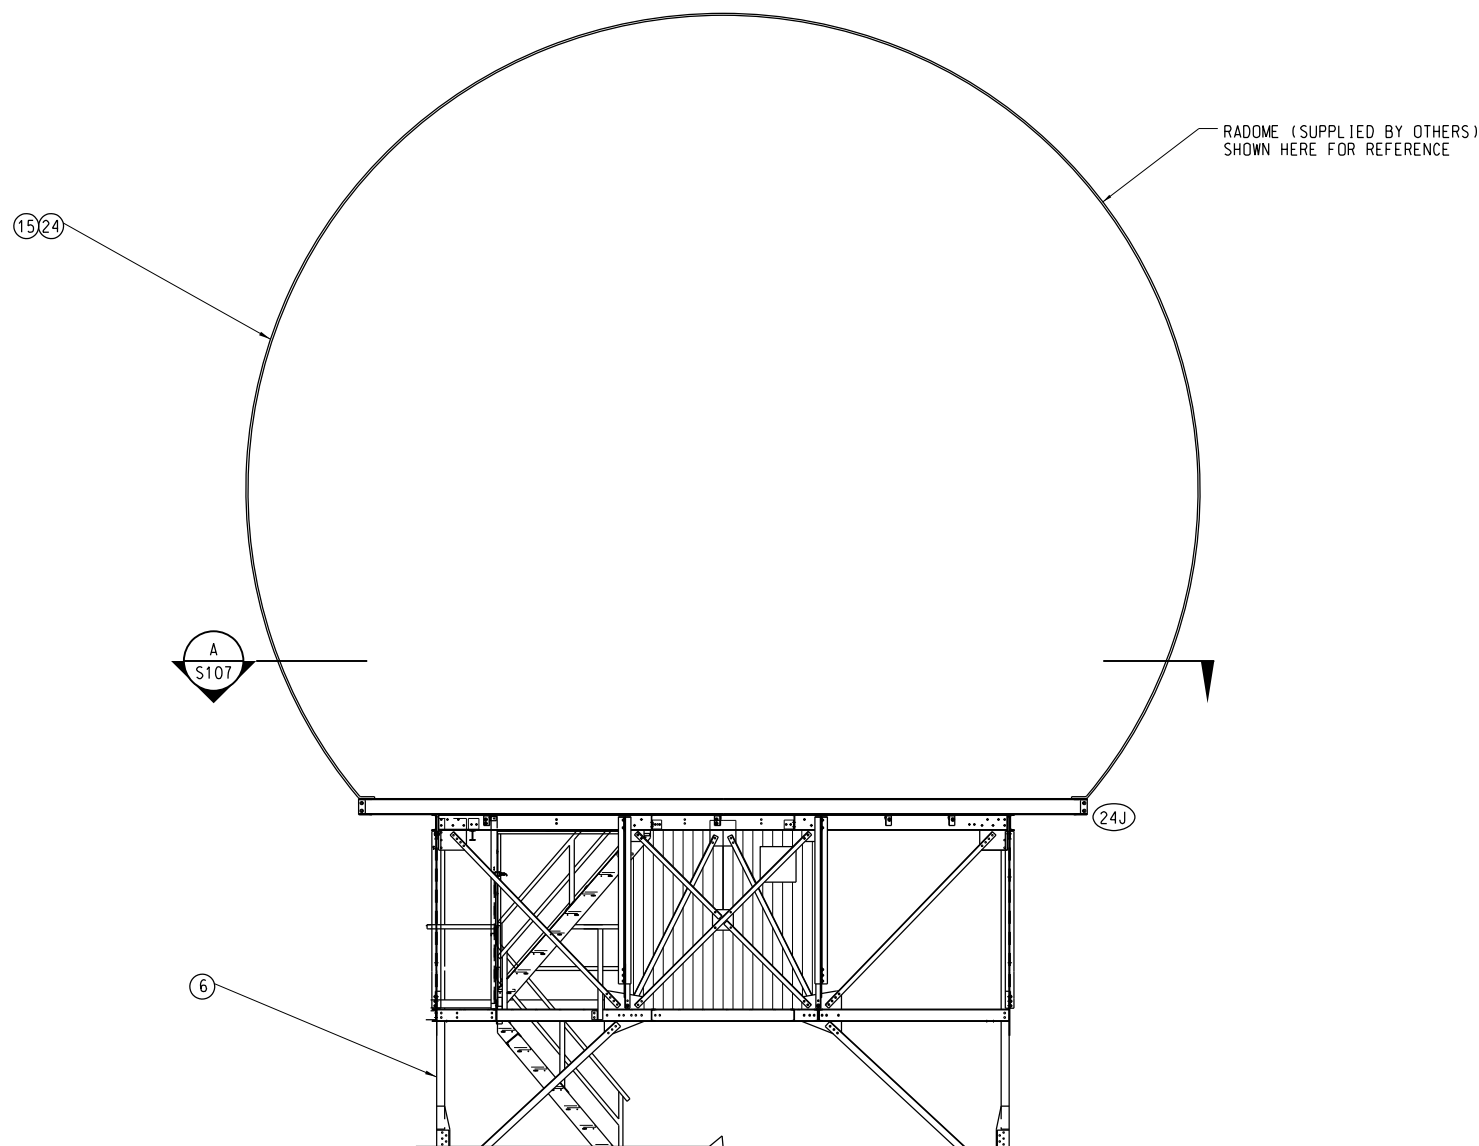

NOTE: CONTRACTOR SHALL COMPLY WITH RADOME MANUFACTURER MOUNTING/ANCHORAGE CUT SHEETS. THESE CONTRACT DRAWINGS DO NOT INCORPORATE ANY RADOME DESIGN.

**A** RADOME ATCBI TOWER  
S106 NOT TO SCALE

NOTES:

1. ITEM DETAILS CAN BE FOUND ON DRAWING S001 THRU S044. NUMBER CONTAINED IN DESIGNATIONS REFERS TO A SPECIFIC SHEET. FOR EXAMPLE, B32L DENOTES DETAIL "B" ON SHEET S032 IN A LEFT HAND CONFIGURATION.  
EXCEPTION - TREADPLATE IS DETAILED ON SHEETS S035 AND S036.
2. ALL HARDWARE 1/2" DIA OR LARGER SHALL BE TORQUED AT FINAL ASSEMBLY USING "TURN-OF-THE-NUT" METHOD IN ACCORDANCE WITH AISC GUIDELINES.
- SUMMARY - PRIOR TO TORQUING, ALL BOLTS SHALL BE BROUGHT INTO A "SNUG OBTAINED BY TIGHT" CONDITION. SNUG TIGHT IS DEFINED AS THE TIGHTNESS A FEW IMPACTS OF AN IMPACT WRENCH OR THE FULL EFFORT OF A MAN USING AN ORDINARY SPUD WRENCH. PARTS OF A JOINT SHOULD BE IN GOOD CONTACT WITH EACH OTHER.
- ALL 5/8" OR 3/4" DIA BOLTS SHALL BE TIGHTENED ADDITIONALLY BY ROTATING THE NUT RELATIVE TO THE BOLT BY 1/3 OF A TURN, PLUS OR MINUS 30°.
- HARDWARE THAT IS TORQUED AND THEN LOOSENEED SHALL NOT BE RE-USED.

3. NOT USED


4. BOLT SCHEDULE:

- (DD) 3/8-16 UNC X 1.50" LG  
82° FLAT HD. SCREW WITH PALNUT  
(J) 1-8 UNC X 3.00" LG  
(C) 5/8-11 UNC X 2.00" LG  
(T) 3/4-10 UNC X 2.00" LG  
(A) 5/8-11 UNC X 1.50" LG  
(W) 3/4-10 UNC X 2.50" LG  
(V) 3/4-10 UNC X 2.25" LG  
(AA) 3/8-16 UNC X 1.50" LG  
(BB) 3/8-16 UNC X 1.25" LG  
BW INDICATES BEVEL WASHERS FOR BOLT SIZE REQUIREMENT  
RF 3/8" THICK RING FILL

5. A = 13.98" ±.09", 80 PLACES  
HOLE DIAMETERS ARE .81" ±.03" ON A 14'-10" ±1/8" RADIUS  
FOR ANY 5 CONSECUTIVE HOLES, 5 X A = 69.90" ±.09" REF


FLATNESS OF RADOME RING TO BE 1/8" OVER 30" LENGTH, 1/4" MAX REF  
SEE DRAWING S032

SCALES SHOWN FOR 22" X 34" SHEET. ADJUST SCALES FOR OTHER SIZES.																																																																																	
<div><div><div>HARTRAMPF</div><div>7000 CENTRAL PARKWAY, SUITE 1475 ATLANTA, GEORGIA 30328 HEI JOB NUMBER: 212042.00</div></div><table><tr><td>REV</td><td>APPROVED DATE</td><td>DESCRIPTION</td><td>JCN</td><td>REDLINE DATE</td><td>APVD</td></tr><tr><td colspan="6">DEPARTMENT OF TRANSPORTATION FEDERAL AVIATION ADMINISTRATION ATO TECHNICAL OPERATIONS EASTERN SERVICE AREA</td></tr><tr><td colspan="6">ATCBI ATCBI-6 RADOME ELEVATION</td></tr><tr><td colspan="6">FREEPORT BAHAMAS</td></tr><tr><td colspan="2">REVIEWED BY</td><td colspan="2">SUBMITTED BY NEIL BOLEN</td><td colspan="2">APPROVED BY STEVE BRADDY</td></tr><tr><td colspan="2"></td><td colspan="2"></td><td colspan="2"></td></tr><tr><td colspan="2"></td><td colspan="2">DESIGNED SNG</td><td colspan="2">ISSUED BY</td></tr><tr><td colspan="2"></td><td colspan="2">DRAWN SNG</td><td colspan="2">ENGINEERING SERVICES</td></tr><tr><td colspan="2"></td><td colspan="2">CHECKED RAB</td><td colspan="2">SURV/WEATHER</td></tr><tr><td colspan="2"></td><td colspan="2">DATE 4/23/2012</td><td colspan="2">JCN 621767</td></tr><tr><td colspan="2"></td><td colspan="2">DRAWING NO</td><td colspan="2">REV</td></tr><tr><td colspan="2"></td><td colspan="2">BHF-D-621767-S106</td><td colspan="2"></td></tr></table></div>										REV	APPROVED DATE	DESCRIPTION	JCN	REDLINE DATE	APVD	DEPARTMENT OF TRANSPORTATION FEDERAL AVIATION ADMINISTRATION ATO TECHNICAL OPERATIONS EASTERN SERVICE AREA						ATCBI ATCBI-6 RADOME ELEVATION						FREEPORT BAHAMAS						REVIEWED BY		SUBMITTED BY NEIL BOLEN		APPROVED BY STEVE BRADDY										DESIGNED SNG		ISSUED BY				DRAWN SNG		ENGINEERING SERVICES				CHECKED RAB		SURV/WEATHER				DATE 4/23/2012		JCN 621767				DRAWING NO		REV				BHF-D-621767-S106			
REV	APPROVED DATE	DESCRIPTION	JCN	REDLINE DATE	APVD																																																																												
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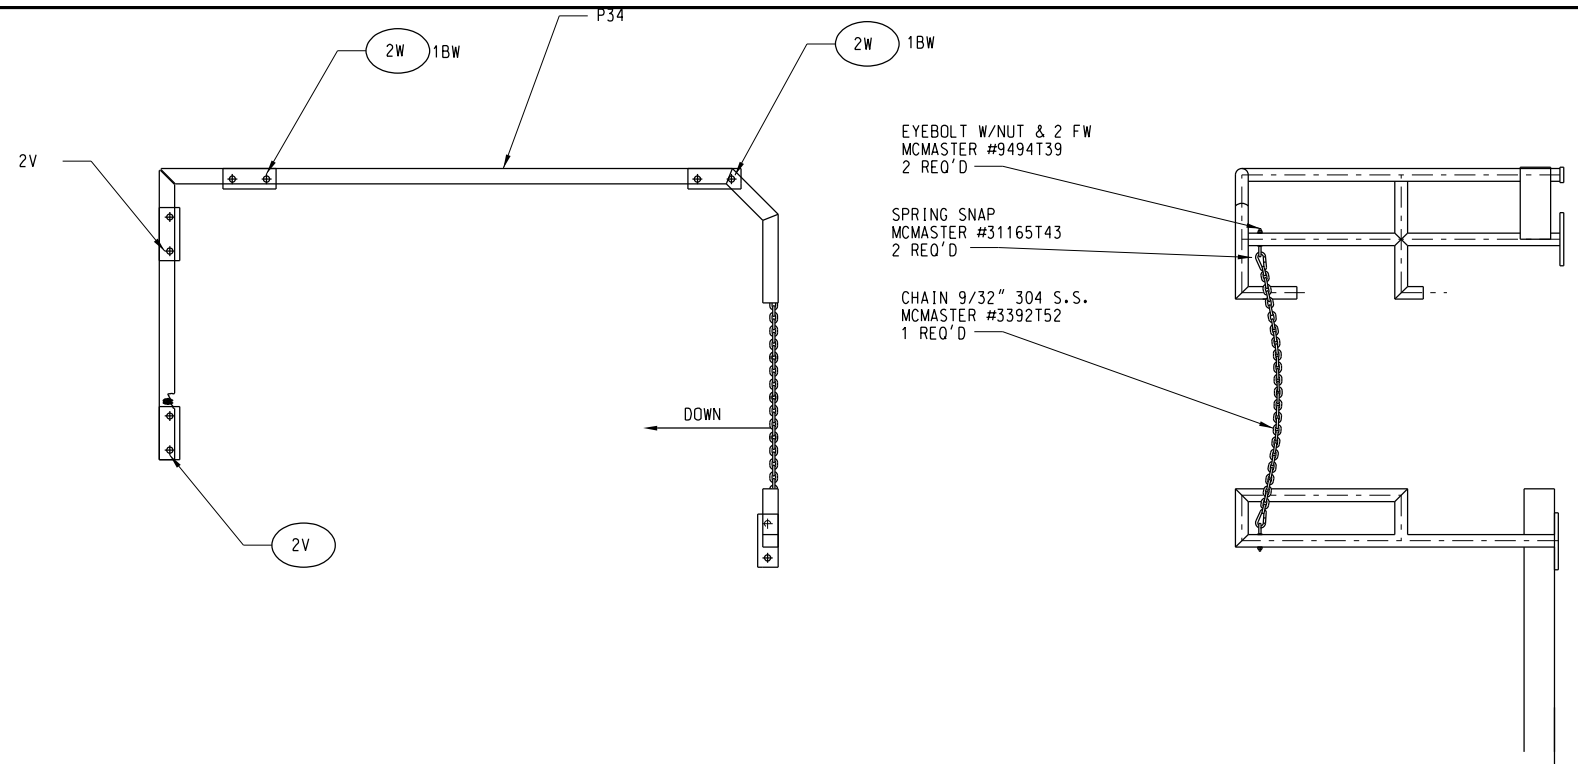


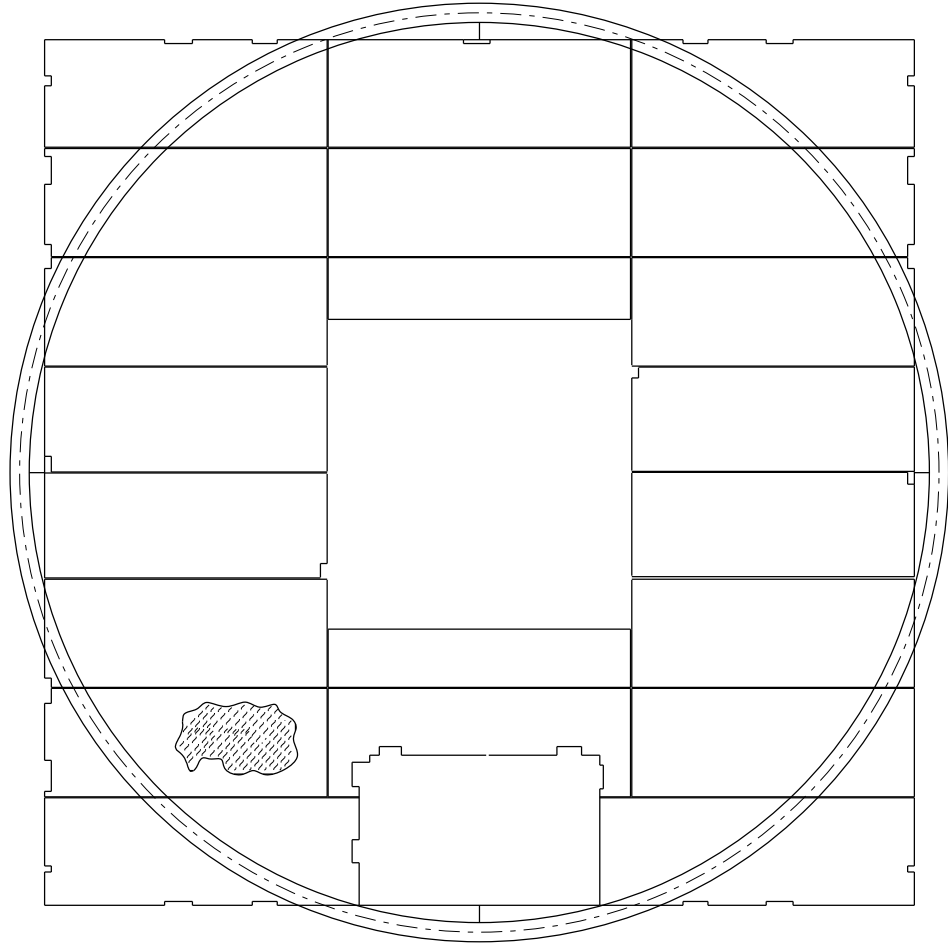NOTE: SEE S027 & S035 FOR FLOOR PLATE CALLOUTS AND DIMENSIONAL INFORMATION.


**A** RADOME MOUNTING KIT  
S107 SCALE: 3/8" = 1'-0"

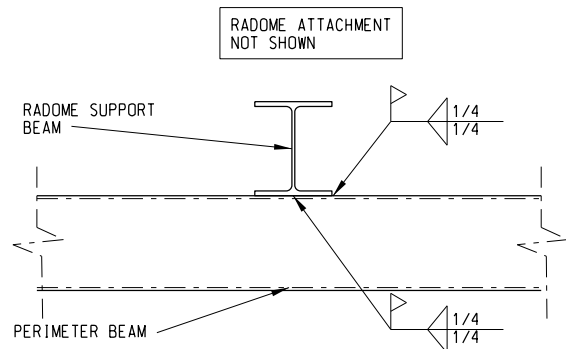

**B** RADOME BEAM ATTACHMENT  
S107 NOT TO SCALE





**E** HANDRAILING DETAIL  
S107 NOT TO SCALE

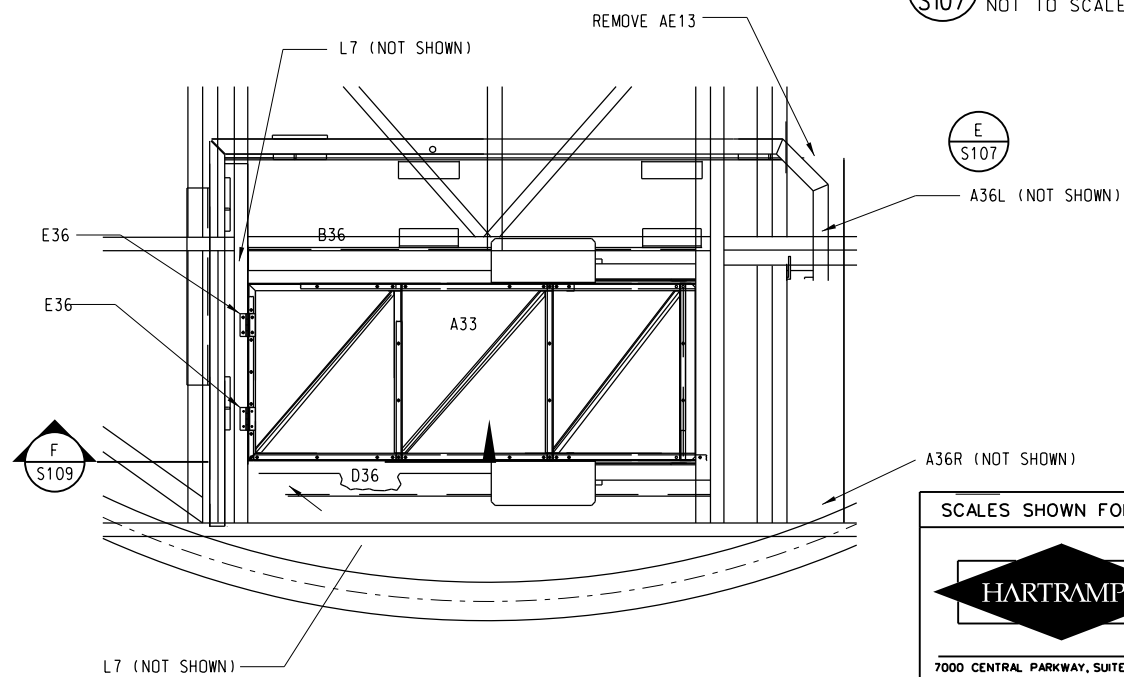


**D** ACCESS DOOR DETAIL  
S107 SCALE: 3/4" = 1'-0"

## NOTES

1. ALL STEEL HAS BEEN FABRICATED WITH THE EXCEPTION OF THOSE MEMBERS NOTED "REPLACEMENT MEMBERS" ON PIECE SHEETS. CONTRACTOR IS RESPONSIBLE FOR VERIFYING ALL PIECES PRIOR TO THE START OF STEEL PLACEMENT.

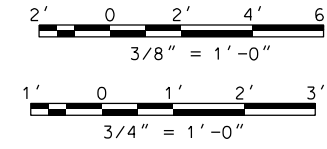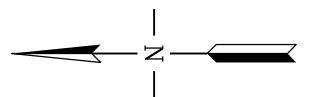

SCALES SHOWN FOR 22" X 34" SHEET. ADJUST SCALES FOR OTHER SIZES.									
7000 CENTRAL PARKWAY, SUITE 1475 ATLANTA, GEORGIA 30328 HEI JOB NUMBER: 212042.00									
DEPARTMENT OF TRANSPORTATION <b>FEDERAL AVIATION ADMINISTRATION</b> ATO TECHNICAL OPERATIONS EASTERN SERVICE AREA									
ATCBI ATCBI-6 TOP PLATFORM DECKING & RADOME RING LAYOUT									
FREEPORT <span style="float: right;">BAHAMAS</span>									
REV	APPROVED DATE	DESCRIPTION				JCN	REDLINE DATE	APVD	
REVIEWED BY		SUBMITTED BY				APPROVED BY			
		NEIL BOLEN				STEVE BRADY			
DESIGNED		ISSUED BY		DATE		JCN		REV	
		ENGINEERING SERVICES SURV/WEATHER		4/23/2012		621767			
DRAWN				DRAWING NO					
CHECKED				BHF-D-621767-S107					

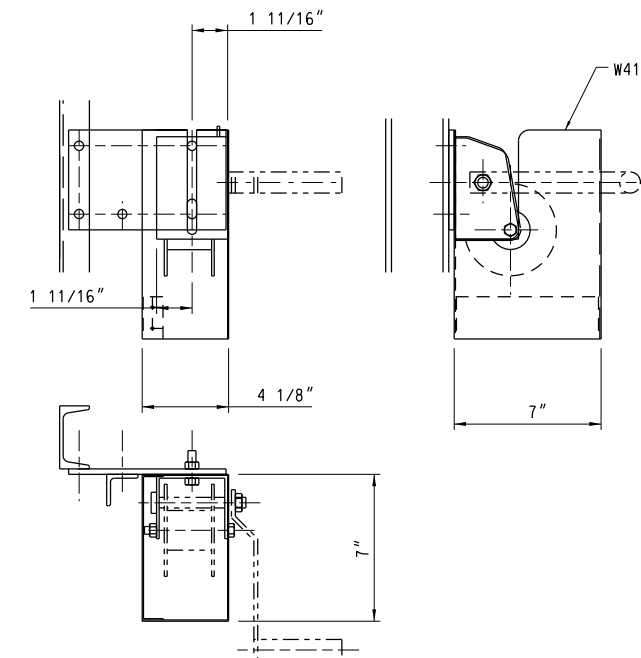


PULLEY/BLOCK, 3/16" DIA CABLE  
3/8-16 UNC X 2 1/2" LG  
EYEBOLT & LOCK WASHER (CRES)

LOCATE WIRE ROPE  
CLIP WITH DOOR  
IN OPEN POSITION

4'-9"  
OPEN POSITION


W  
S109 W41


ACCESS DOOR VIEW  
NOT TO SCALE

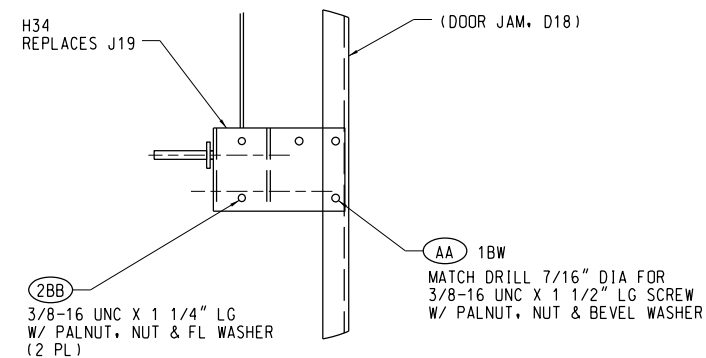


 ACCESS DOOR VIEW  
 NOT TO SCALE


1. ALL STEEL HAS BEEN FABRICATED WITH THE EXCEPTION OF THOSE MEMBERS NOTED "REPLACEMENT MEMBERS" ON PIECE SHEETS. CONTRACTOR IS RESPONSIBLE FOR VERIFYING ALL PIECES PRIOR TO THE START OF STEEL PLACEMENT.

SCALES SHOWN FOR 22" X 34" SHEET. ADJUST SCALES FOR OTHER SIZES.									
									
7000 CENTRAL PARKWAY, SUITE 1475 ATLANTA, GEORGIA 30328			REV	APPROVED DATE	DESCRIPTION	JCN	REDLINE DATE	APVD	
HEI JOB NUMBER: 212042.00			DEPARTMENT OF TRANSPORTATION <b>FEDERAL AVIATION ADMINISTRATION</b> ATO TECHNICAL OPERATIONS EASTERN SERVICE AREA						
			ATCBI ATCBI-6 TOP PLATFORM ACCESS DETAILS						
			FREEPORT BAHAMAS						
			REVIEWED BY	SUBMITTED BY  <b>NEIL BOLEN</b>				APPROVED BY  <b>STEVE BRADY</b>	
			DESIGNED	SNG	ISSUED BY	DATE	4/23/2012	JCN	621767
			DRAWN	SNG	ENGINEERING SERVICES	DRAWING NO	BHF-D-621767-S109		
			CHECKED	RAR	SURV/WEATHER	REVISIONS 1. 4/23/2012 RAR 1.00			

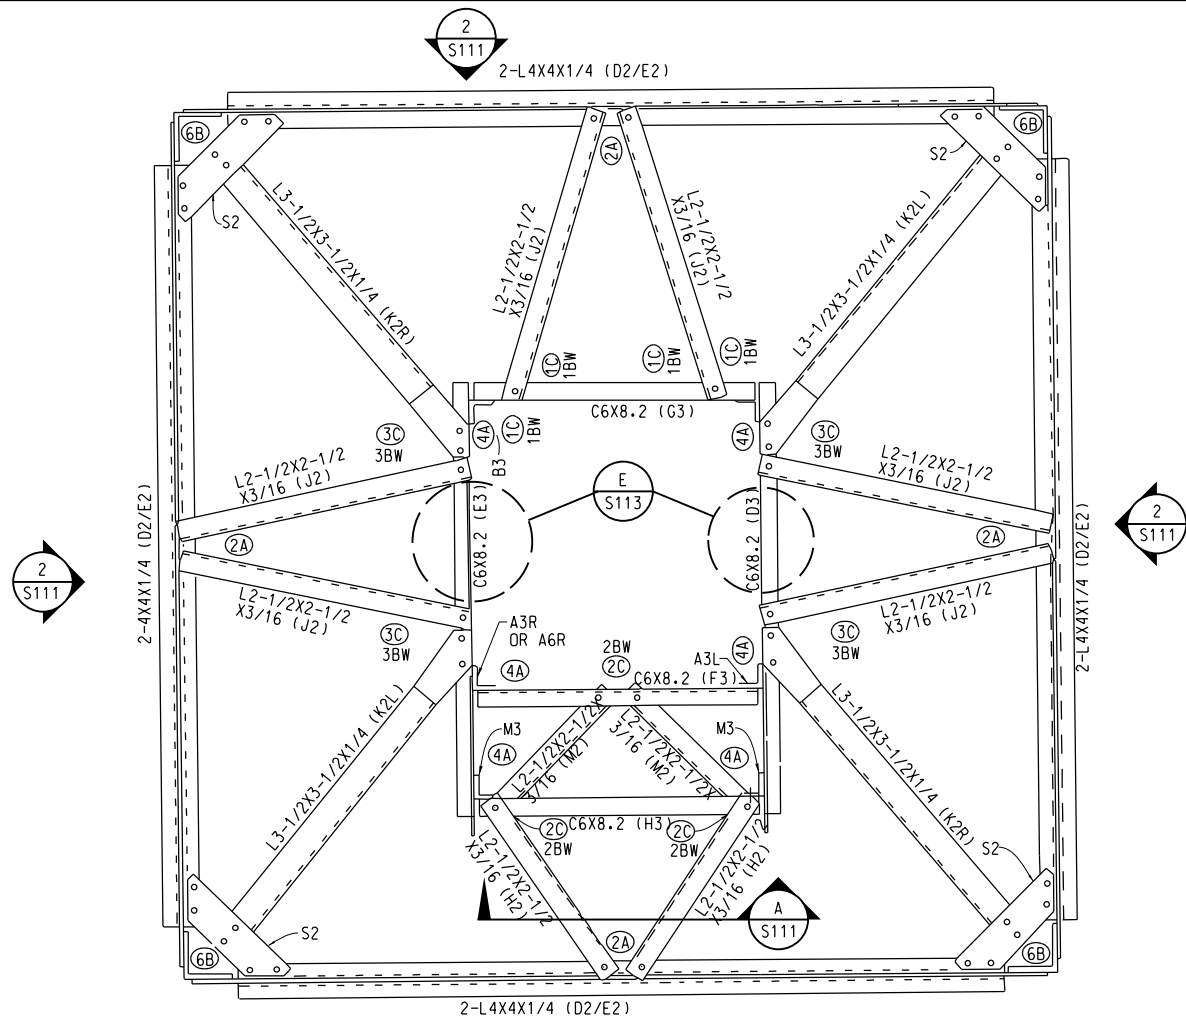

NOTE: SEE 1/S113 FOR LANDING GRATING AND ATTACHMENT INFORMATION NOT SHOWN.


**1 PLAN VIEW**  
NOT TO SCALE

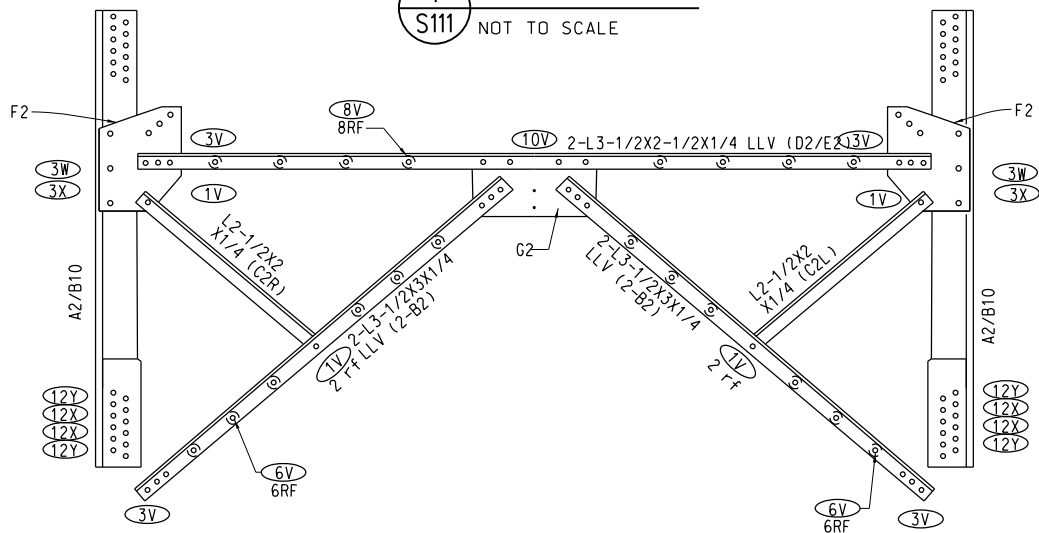

NOTE: TYPICAL COMPONENTS, HANDRAILS, HANGER-ANGLES, AND STAIR LAYOUT DEPEND ON SECTION LOCATION. (SEE CHART)

**2 TYP FLOOR BRACING**  
NOT TO SCALE

DASH NO.	LOCATION
-301	GROUND/LOWER LEVEL, HVY
-302	GROUND LEVEL, STD
-303	MID LEVEL
-304	MID LEVEL/SUB-MEZZANINE

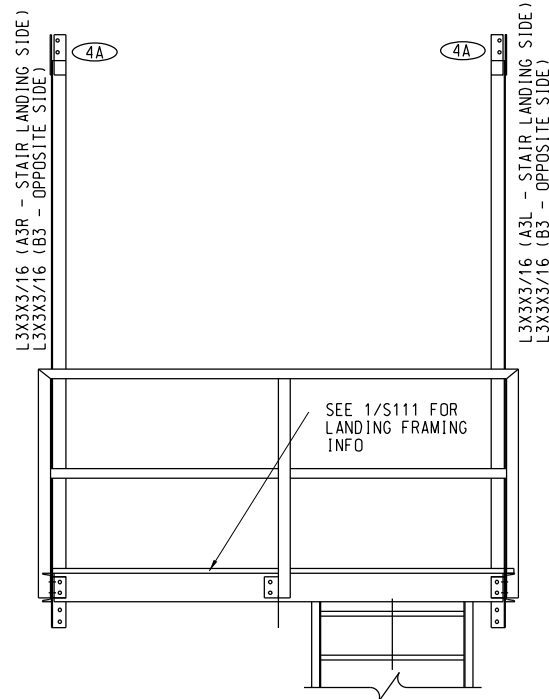

NOTE: HANGER ANGLES ARE APPLICABLE FOR ALL LEVELS BELOW MEZZANINE.

**A TOWER SECTION**  
NOT TO SCALE

## NOTES:

- ITEM DETAILS CAN BE FOUND ON DRAWINGS S001 THRU S044. NUMBER CONTAINED IN DESIGNATION REFERS TO SHEET. FOR EXAMPLE, DETAIL J2 CAN BE FOUND ON SHEET S002.
- ALL HARDWARE 1/2" DIAMETER OR LARGER SHALL BE TORQUED AT FINAL ASSEMBLY USING "TURN-OF-THE-NUT" METHOD IN ACCORDANCE WITH AISC GUIDELINES, 9TH EDITION.

**SUMMARY** - PRIOR TO TORQUING, ALL BOLTS SHALL BE BROUGHT INTO A "SNUG TIGHT" CONDITION. SNUG TIGHT IS DEFINED AS THE TIGHTNESS OBTAINED BY A FEW IMPACTS OF AN IMPACT WRENCH OR THE FULL EFFORT OF A MAN USING AN ORDINARY SPUD WRENCH. PARTS OF A JOINT SHOULD BE IN GOOD CONTACT WITH EACH OTHER.

- ALL 5/8" OR 3/4" DIAMETER BOLTS SHALL BE TIGHTENED ADDITIONALLY BY ROTATING THE NUT RELATIVE TO THE BOLT BY 1/3 OF A TURN, PLUS OR MINUS 30°.

- HARDWARE THAT IS TORQUED AND THEN LOOSENED SHALL NOT BE RE-USED.

- USE FLAT WASHER ON NUT SIDE OF CONNECTION.

- THE CONTACT AREA OF ALL GALVANIZED STRUCTURAL MEMBERS AND PLATES SHALL BE LIGHTLY ROUGHENED USING A HAND WIRE BRUSH ONLY. AS A MINIMUM THIS INCLUDES THE AREA AROUND ALL HOLES, BOTH SIDES OF THE MEMBER/PLATE.

- ALL STEEL HAS BEEN FABRICATED WITH THE EXCEPTION OF THOSE MEMBERS NOTED "REPLACEMENT MEMBERS" ON PIECE SHEETS. CONTRACTOR IS RESPONSIBLE FOR VERIFYING ALL PIECES PRIOR TO THE START OF STEEL PLACEMENT.


- BOLT SCHEDULE:

BB	3/8-16 UNC, 1.25" LG, WITH PALNUT
A	5/8-11 UNC, 1.50" LG
B	5/8-11 UNC, 1.75" LG
C	5/8-11 UNC, 2.00" LG
D	5/8-11 UNC, 2.25" LG
V	3/4-10 UNC, 2.25" LG
W	3/4-10 UNC, 2.50" LG
X	3/4-10 UNC, 2.75" LG
Y	3/4-10 UNC, 3.00" LG
rf	1/8" THICK RINGFILL
RF	1/2" THICK RINGFILL
BW	BEVEL WASHER

- ALL BOLTS TO HAVE FLAT WASHER AND HEX NUT.

## KEY:


NO. OF BOLT — SIZE AND LENGTH

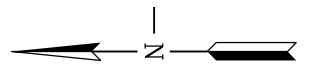


SEE SEPARATE PARTS LIST SHEET S110

SCALES SHOWN FOR 22" X 34" SHEET. ADJUST SCALES FOR OTHER SIZES.


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7000 CENTRAL PARKWAY, SUITE 1475 ATLANTA, GEORGIA 30328 HEI JOB NUMBER: 212042.00		DEPARTMENT OF TRANSPORTATION <b>FEDERAL AVIATION ADMINISTRATION</b> ATO TECHNICAL OPERATIONS EASTERN SERVICE AREA						
		ATCBI ATCBI-6 TYPICAL LEVEL FRAMING & BRACING PLANS						
FREEPORT		BAHAMAS						
REVIEWED BY		SUBMITTED BY		APPROVED BY				
		NEIL BOLEN		STEVE BRADDY				
		DESIGNED SNG		ISSUED BY		DATE 4/23/2012		JCN 621767
		DRAWN SNG		ENGINEERING SERVICES		DRAWING NO		REV
		CHECKED RAB		SURV/WEATHER		BHF-D-621767- S111		

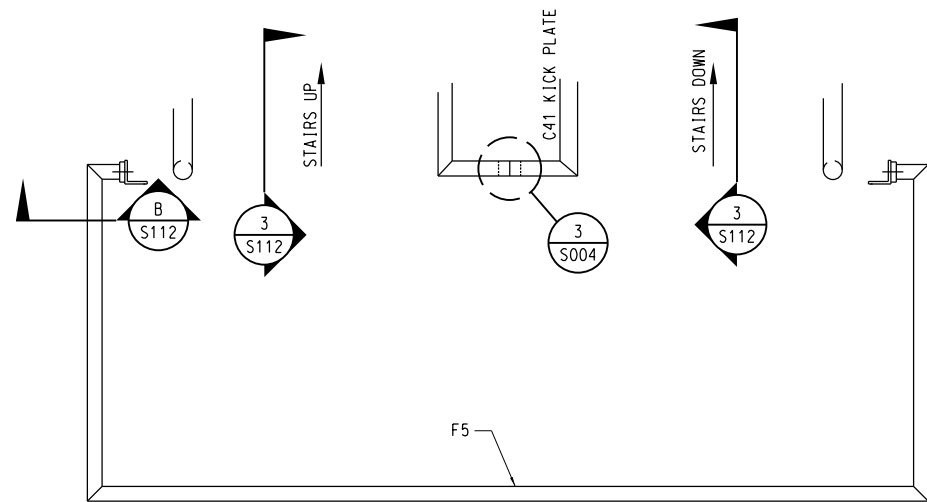


**1** STAIR PLATFORM RAIL  
S112 NOT TO SCALE

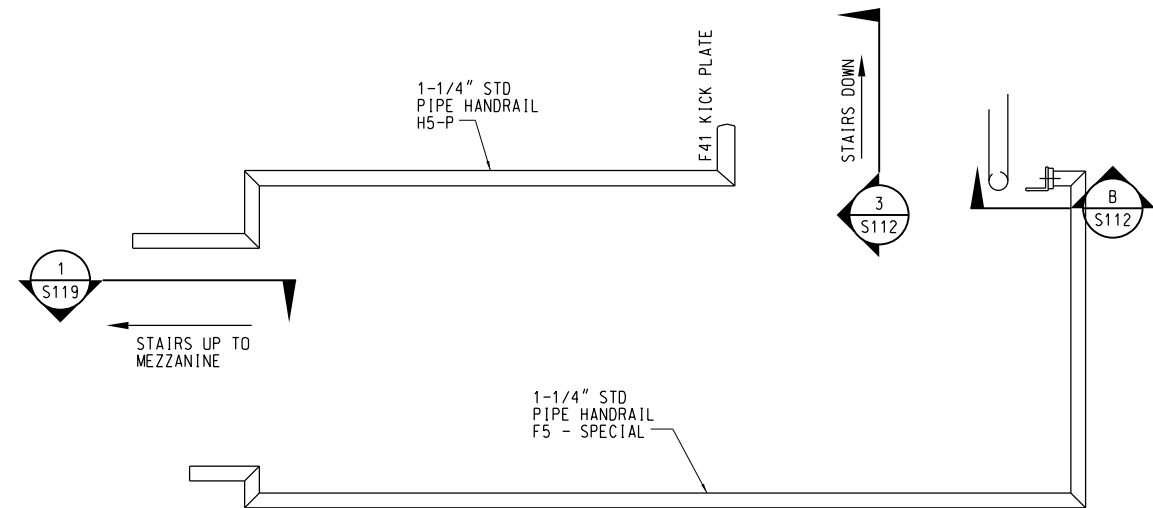


**2** STAIR PLATFORM RAIL  
S112 NOT TO SCALE

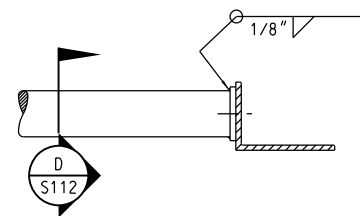


**C** SECTION  
S112 NOT TO SCALE

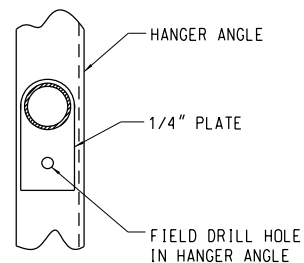


**D** SECTION  
S112 NOT TO SCALE

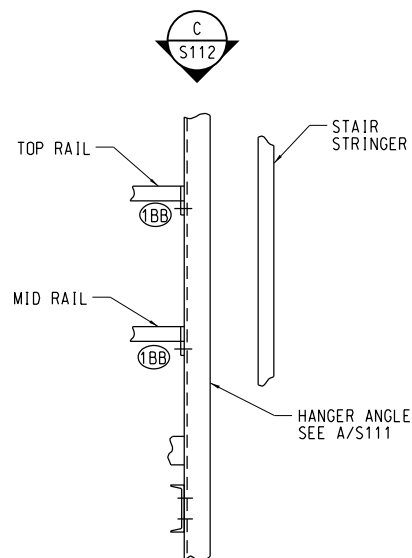

**B** SECTION  
S112 NOT TO SCALE

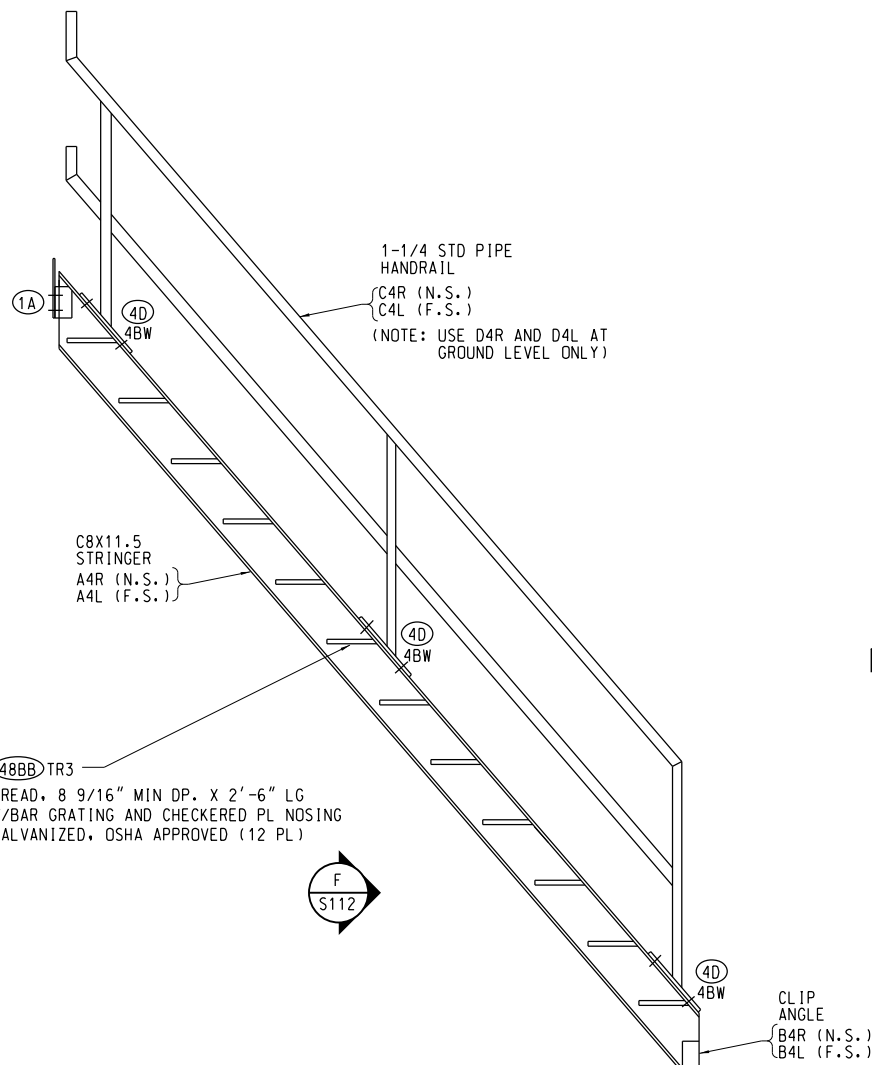

(REF NEXT HIGHER ASSEMBLY FOR POSITION)  
**3** STAIR DETAIL - 10 FT SECTION  
S112 NOT TO SCALE

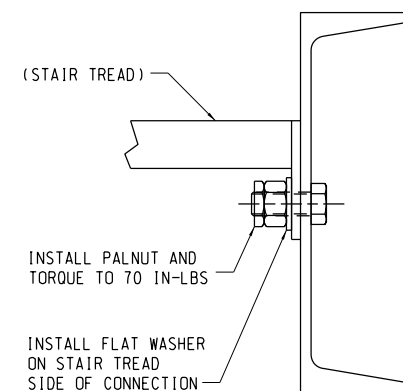


**F** VIEW F  
S112 NOT TO SCALE

## NOTES


- ALL STEEL HAS BEEN FABRICATED WITH THE EXCEPTION OF THOSE MEMBERS NOTED "REPLACEMENT MEMBERS" ON PIECE SHEETS. CONTRACTOR IS RESPONSIBLE FOR VERIFYING ALL PIECES PRIOR TO THE START OF STEEL PLACEMENT.

SCALES SHOWN FOR 22" X 34" SHEET. ADJUST SCALES FOR OTHER SIZES.										
<div><div>HARTRAMPF</div><div>7000 CENTRAL PARKWAY, SUITE 1475 ATLANTA, GEORGIA 30328</div><div>HEI JOB NUMBER: 212042.00</div></div>										
REV	APPROVED DATE	DESCRIPTION				JCN	REDLINE DATE	APVD		
DEPARTMENT OF TRANSPORTATION FEDERAL AVIATION ADMINISTRATION ATO TECHNICAL OPERATIONS EASTERN SERVICE AREA										
ATCBI ATCBI-6 TYPICAL LEVEL STAIR & HANDRAIL DETAILS										
FREEPORT					BAHAMAS					
REVIEWED BY		SUBMITTED BY				APPROVED BY				
		NEIL BOLEN				STEVE BRADY				
		DESIGNED		SNG	ISSUED BY		DATE	4/23/2012	JCN	621767
		DRAWN		SNG	ENGINEERING SERVICES		DRAWING NO		BHF-D-621767-S112	
		CHECKED		RAB	SURV/WEATHER				REV	

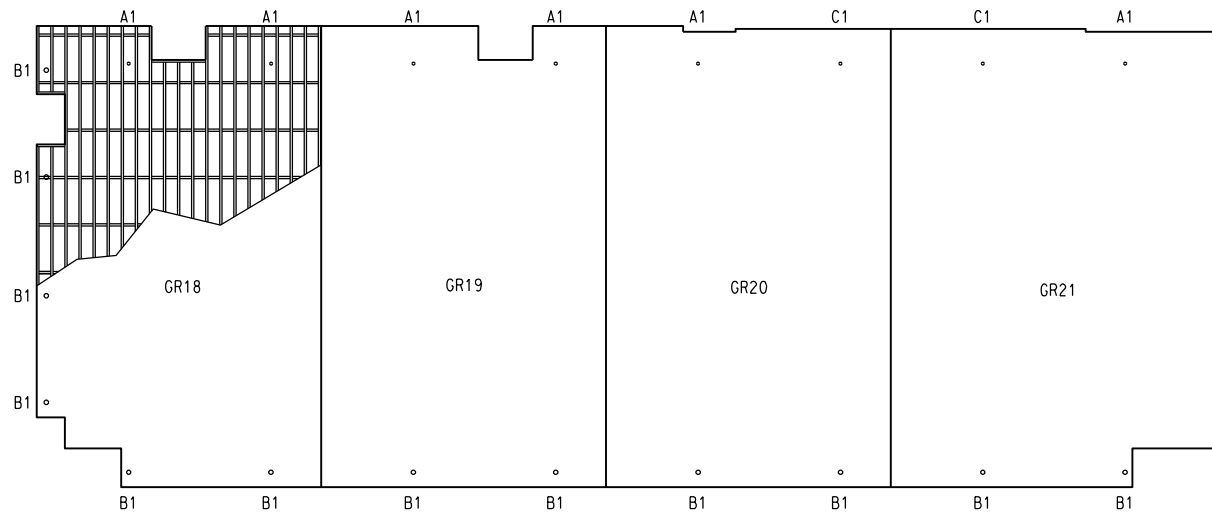


- NOTES:
- 1. FASTEN WITH SADDLE CLIPS, AND GRATING CLAMPS. SEE DETAILS 2, 3 AND 4.
  - 2. FOR GRATING DETAILS AND DIMENSIONAL INFO, SEE DRAWING S040.

1 PLATFORM GRATING  
S113 NOT TO SCALE

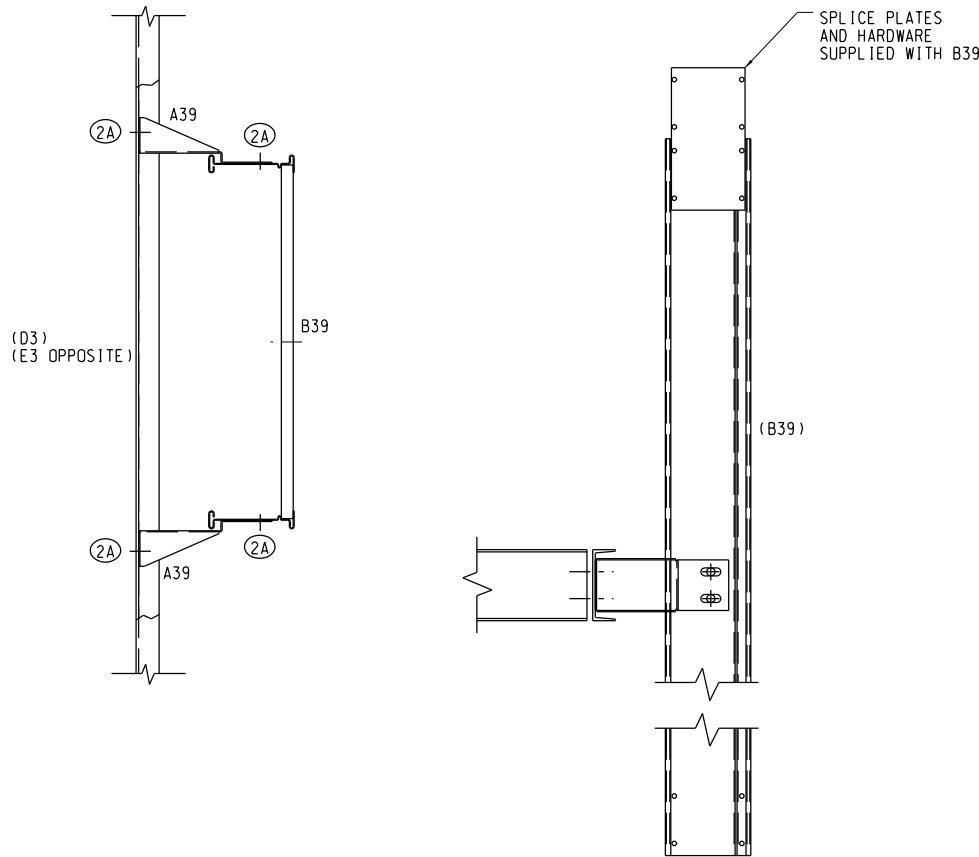

E CABLE TRAY DETAILS  
S113 NOT TO SCALE

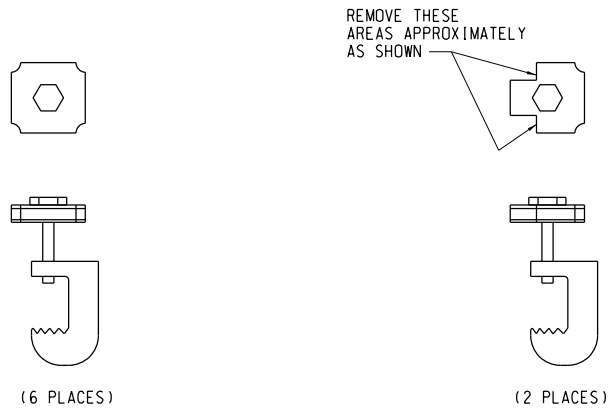


NOTE: GRATING FASTENER FOR 3/16" X 1 1/4" (KLEMP TYPE H-1)

NOTE: GRATING FASTENER FOR 3/16" X 1 1/4" (KLEMP TYPE H-1)

2 GRATING CLAMP MARKED "A1"  
S113 NOT TO SCALE

3 MODIFIED CLAMP GRATING CLAMP MARKED "C1"  
S113 NOT TO SCALE

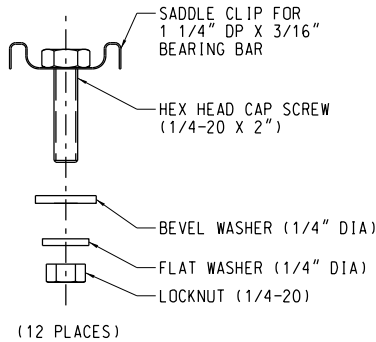

(12 PLACES)


4 SADDLE CLIP ASSEMBLY MARKED "B1"  
S113 NOT TO SCALE

- NOTES
- 1. ALL STEEL HAS BEEN FABRICATED WITH THE EXCEPTION OF THOSE MEMBERS NOTED "REPLACEMENT MEMBERS" ON PIECE SHEETS. CONTRACTOR IS RESPONSIBLE FOR VERIFYING ALL PIECES PRIOR TO THE START OF STEEL PLACEMENT.

SCALES SHOWN FOR 22" X 34" SHEET. ADJUST SCALES FOR OTHER SIZES.									
7000 CENTRAL PARKWAY, SUITE 1475 ATLANTA, GEORGIA 30328 HEI JOB NUMBER: 212042.00									
DEPARTMENT OF TRANSPORTATION FEDERAL AVIATION ADMINISTRATION ATO TECHNICAL OPERATIONS EASTERN SERVICE AREA									
ATCBI ATCBI-6 TYPICAL LEVEL GRATING & CABLE TRAY DETAILS									
FREEPORT BAHAMAS									
REVIEWED BY		SUBMITTED BY NEIL BOLEN			APPROVED BY STEVE BRADDY				
		DESIGNED SNG			ISSUED BY ENGINEERING SERVICES SURV/WEATHER		DATE 4/23/2012		JCN 621767
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		CHECKED RAB					BHF-D-621767-S113		



BOLT SCHEDULE:

(A)	INDICATES 5/8" DIA X 1 1/2" LG GALVANIZED BOLT	(U)	INDICATES 3/4" DIA X 1 3/4" LG GALVANIZED BOLT
(B)	INDICATES 5/8" DIA X 1 3/4" LG GALVANIZED BOLT	(V)	INDICATES 3/4" DIA X 2 1/4" LG GALVANIZED BOLT
(C)	INDICATES 5/8" DIA X 2" LG GALVANIZED BOLT	(W)	INDICATES 3/4" DIA X 2 1/2" LG GALVANIZED BOLT
(D)	INDICATES 5/8" DIA X 2 1/4" LG GALVANIZED BOLT	(X)	INDICATES 3/4" DIA X 2 3/4" LG GALVANIZED BOLT
(E)	INDICATES 5/8" DIA X 2 1/2" LG GALVANIZED BOLT	(Y)	INDICATES 3/4" DIA X 3" LG GALVANIZED BOLT
(F)	INDICATES 5/8" DIA X 2 3/4" LG GALVANIZED BOLT	(Z)	INDICATES 1" DIA X 2" LG GALVANIZED BOLT
(G)	INDICATES 5/8" DIA X 3 1/2" LG GALVANIZED BOLT	(AA)	INDICATES 3/8" DIA X 1 1/2" LG GALVANIZED BOLT WITH PALNUT
(R)	INDICATES .82" I.D. X 1.5" O.D. X .031" SHIM	(BB)	INDICATES 3/8" DIA X 1 1/4" LG GALVANIZED BOLT WITH PALNUT
(S)	INDICATES .82" I.D. X 1.5" O.D. X .062" SHIM	(CC)	INDICATES 3/8" DIA X 1" LG GALVANIZED BOLT WITH PALNUT
(T)	INDICATES 3/4" DIA X 2" LG GALVANIZED BOLT	(DD)	INDICATES 3/8" DIA X 1 1/2" LG 82° FLAT HEAD GALVANIZED SCREW WITH PALNUT
		RF	INDICATES 3/8" RING FILLS FOR BOLT SIZE REQUIREMENT.
		BW	INDICATES BEVEL WASHERS FOR BOLT SIZE REQUIREMENT.

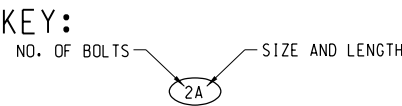

- NOTES:
- ALL FACES ALIKE EXCEPT AS NOTED.
  - ALL BOLTS TO HAVE FLAT WASHER AND HEX NUT.
  - FIELD TO DRILL 13/16" DIA HOLES IN GUSSET PLATE TO MATCH HOLES IN WAVEGUIDE HANGER J3.
  - ALL HARDWARE 1/2" DIAMETER OR LARGER SHALL BE TORQUED AT FINAL ASSEMBLY USING "TURN-OF-THE-NUT" METHOD IN ACCORDANCE WITH AISC GUIDELINES, 9TH EDITION.  
  
SUMMARY - PRIOR TO TORQUING, ALL BOLTS SHALL BE BROUGHT INTO A "SNUG TIGHT" CONDITION. SNUG TIGHT IS DEFINED AS THE TIGHTNESS OBTAINED BY A FEW IMPACTS OF AN IMPACT WRENCH OR THE FULL EFFORT OF A MAN USING AN ORDINARY SPUD WRENCH. PARTS OF A JOINT SHOULD BE IN GOOD CONTACT WITH EACH OTHER.  
  
- ALL 5/8" OR 3/4" DIAMETER BOLTS SHALL BE TIGHTENED ADDITIONALLY BY ROTATING THE NUT RELATIVE TO THE BOLT BY 1/3 OF A TURN, PLUS OR MINUS 30°.  
  
- HARDWARE THAT IS TORQUED AND THEN LOOSENED SHALL NOT BE RE-USED.  
  
- USE FLAT WASHER ON NUT SIDE OF CONNECTION.
  - THE CONTACT AREA OF ALL GALVANIZED STRUCTURAL MEMBERS AND PLATES SHALL BE LIGHTLY ROUGHENED USING A HAND WIRE BRUSH ONLY. AS A MINIMUM, THIS INCLUDES THE AREA AROUND ALL HOLES, BOTH SIDES OF THE MEMBER/PLATE.
- 6 AT FINAL ASSEMBLY, CAULK ALL AROUND WITH LIGHT GRAY G.E. SILPRUF SILICONE SEALANT SCS2008.

SEE SEPARATE PARTS LIST SHEET S114

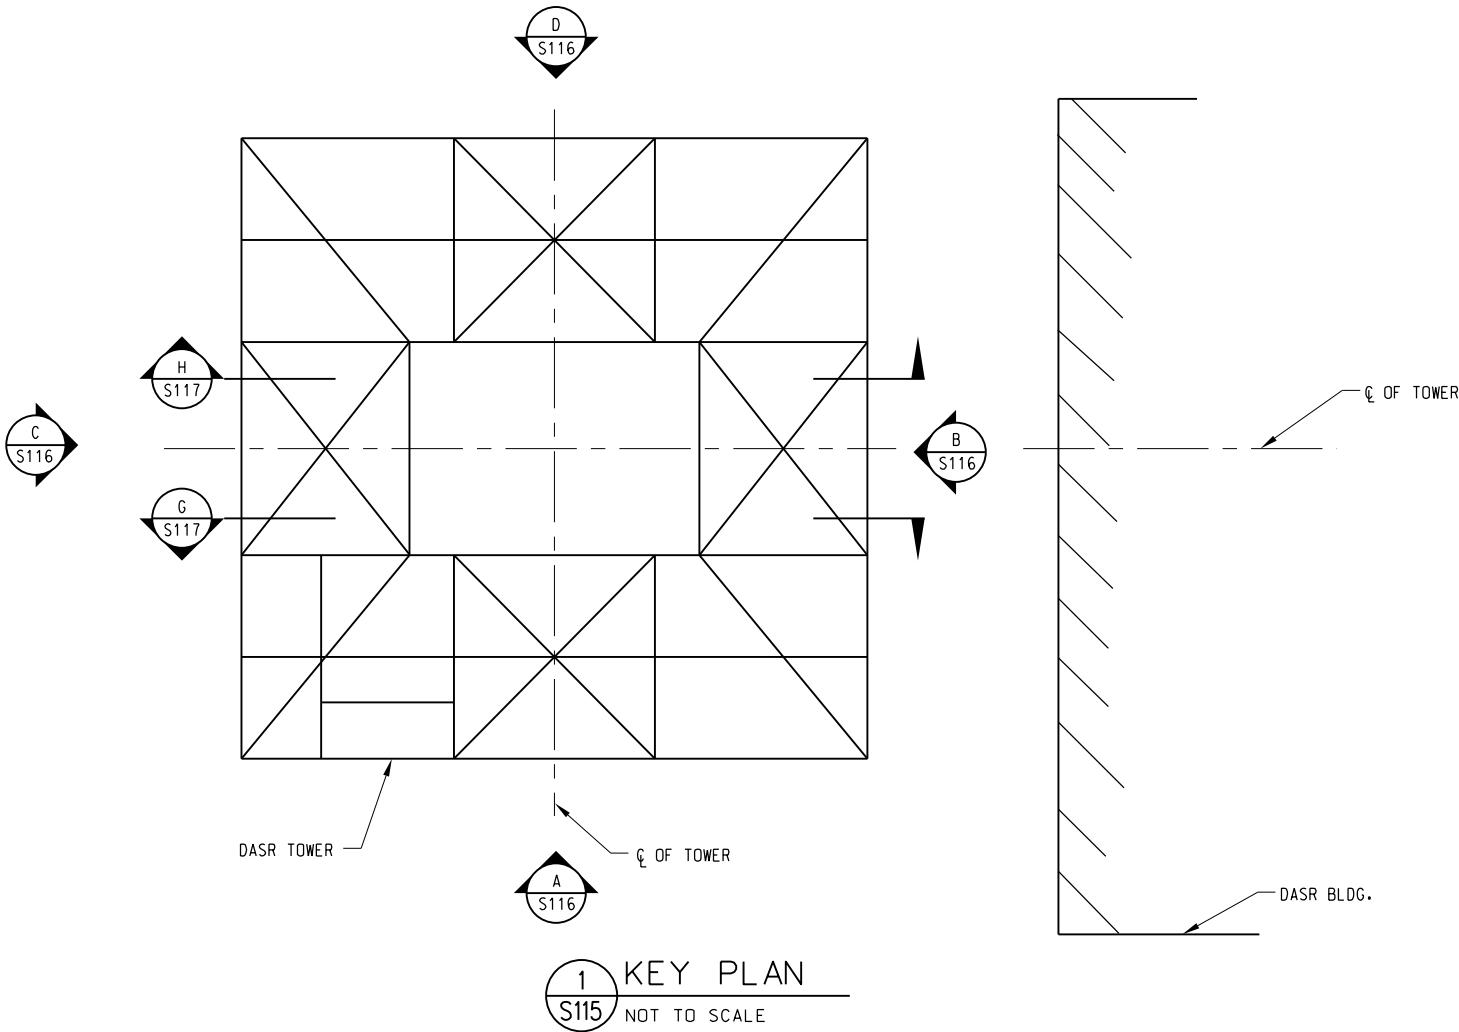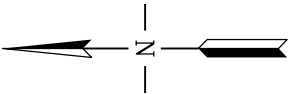


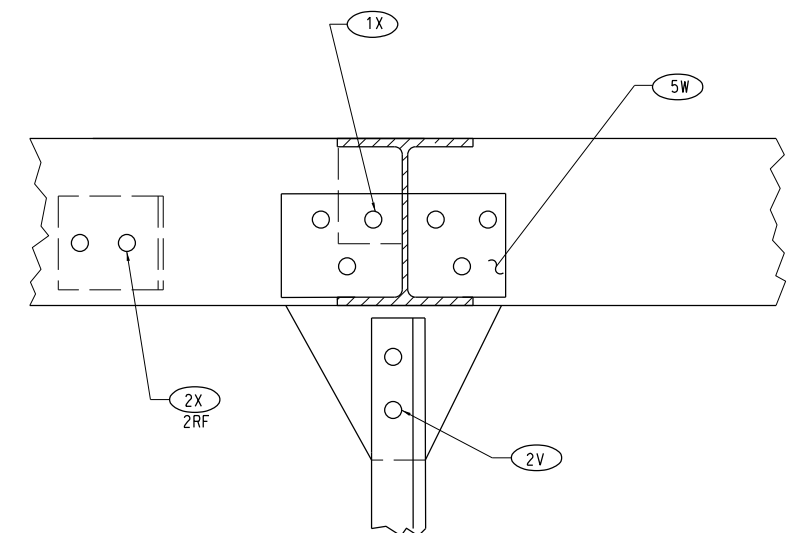
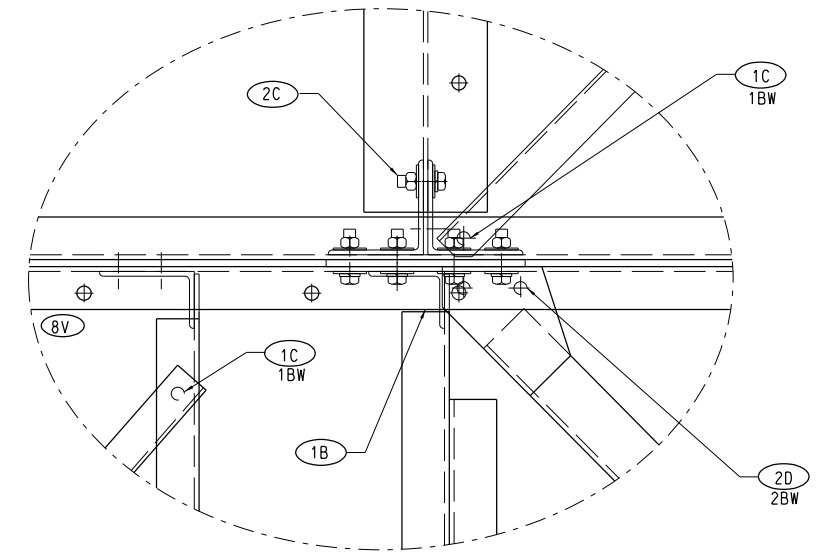
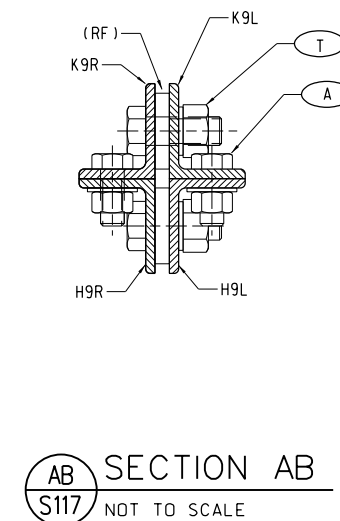
SCALES SHOWN FOR 22" X 34" SHEET. ADJUST SCALES FOR OTHER SIZES.					
 7000 CENTRAL PARKWAY, SUITE 1475 ATLANTA, GEORGIA 30328 HEI JOB NUMBER: 212042.00		REV	APPROVED DATE	DESCRIPTION	JCN
					REDLINE DATE
					APVD
DEPARTMENT OF TRANSPORTATION FEDERAL AVIATION ADMINISTRATION ATO TECHNICAL OPERATIONS EASTERN SERVICE AREA					
ATCBI ATCBI-6 TYPICAL TOWER & BASE BUILDING LAYOUT					
FREEPORT			BAHAMAS		
REVIEWED BY		SUBMITTED BY		APPROVED BY	
		NEIL BOLEN		STEVE BRADDY	
		DESIGNED	SNG	ISSUED BY	DATE
		DRAWN	SNG	ENGINEERING SERVICES	4/23/2012
		CHECKED	RAB	SURV/WEATHER	JCN
				DRAWING NO	621767
				BHF-D-621767- S115	REV






1. ALL STEEL HAS BEEN FABRICATED WITH THE EXCEPTION OF THOSE MEMBERS NOTED "REPLACEMENT MEMBERS" ON PIECE SHEETS. CONTRACTOR IS RESPONSIBLE FOR VERIFYING ALL PIECES PRIOR TO THE START OF STEEL PLACEMENT.

SCALES SHOWN FOR 22" X 34" SHEET. ADJUST SCALES FOR OTHER SIZES.									
									
REV		APPROVED DATE		DESCRIPTION			JCN	REDLINE DATE	APVD
7000 CENTRAL PARKWAY, SUITE 1475 ATLANTA, GEORGIA 30328				DEPARTMENT OF TRANSPORTATION <b>FEDERAL AVIATION ADMINISTRATION</b> ATO TECHNICAL OPERATIONS      EASTERN SERVICE AREA					
HEI JOB NUMBER: 212042.00				ATCBI ATCBI-6 TOP PLATFORM AND MEZZANINE BRACING ELEVATIONS  FREEPORT      BAHAMAS					
REVIEWED BY		SUBMITTED BY			APPROVED BY				
		NEIL BOLEN			STEVE BRADY				
		DESIGNED SNG		ISSUED BY		DATE 4/23/2012		JCN	621767
		DRAWN SNG		ENGINEERING SERVICES		DRAWING NO		REV	
		CHECKED RAR		SURV/WEATHER		BHF-D-621767-S116			








DETAIL F (4 PLACES)

NOT TO SCALE

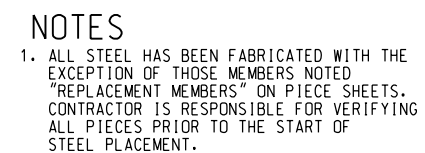


SCALES SHOWN FOR 22" X 34" SHEET. ADJUST SCALES FOR OTHER SIZES.										
<div><div><div>HARTRAMPF</div><div>7000 CENTRAL PARKWAY, SUITE 1475 ATLANTA, GEORGIA 30328</div><div>HEI JOB NUMBER: 212042.00</div></div><div><div>REV</div><div>APPROVED DATE</div><div>DESCRIPTION</div><div>JCN</div><div>REDLINE DATE</div><div>APVD</div></div></div>										
DEPARTMENT OF TRANSPORTATION FEDERAL AVIATION ADMINISTRATION ATO TECHNICAL OPERATIONS      EASTERN SERVICE AREA										
ATCB1 ATCB1-6 MEZZANINE LEVEL INTERIOR BRACING ELEVATIONS										
FREEPORT      BAHAMAS										
REVIEWED BY		SUBMITTED BY				APPROVED BY				
		NEIL BOLEN				STEVE BRADY				
		DESIGNED		SNG	ISSUED BY		DATE	4/23/2012	JCN	621767
		DRAWN		SNC	ENGINEERING SERVICES		DRAWING NO		REV	
		CHECKED		RAR	SURV/WEATHER		BHF-D-621767-S117			

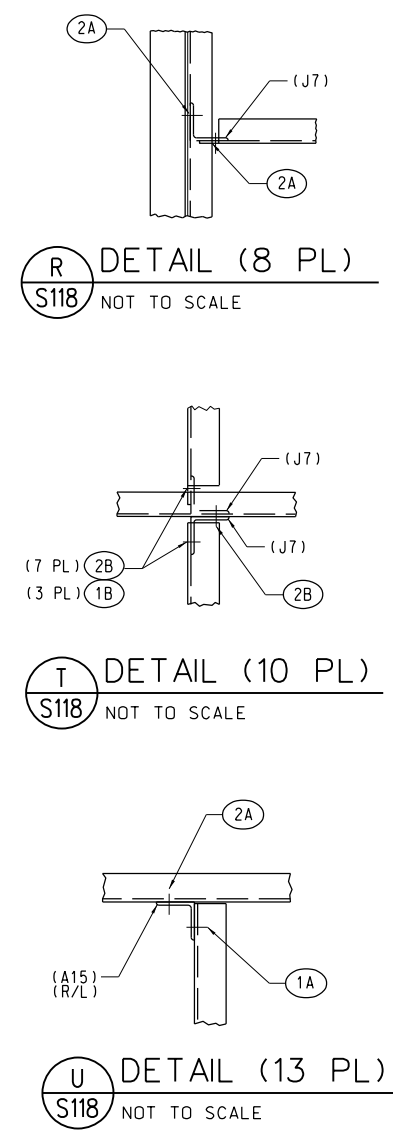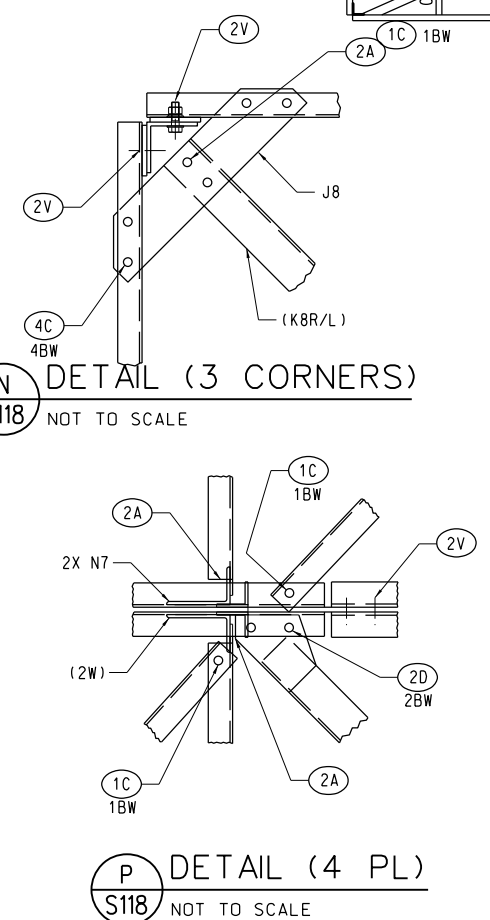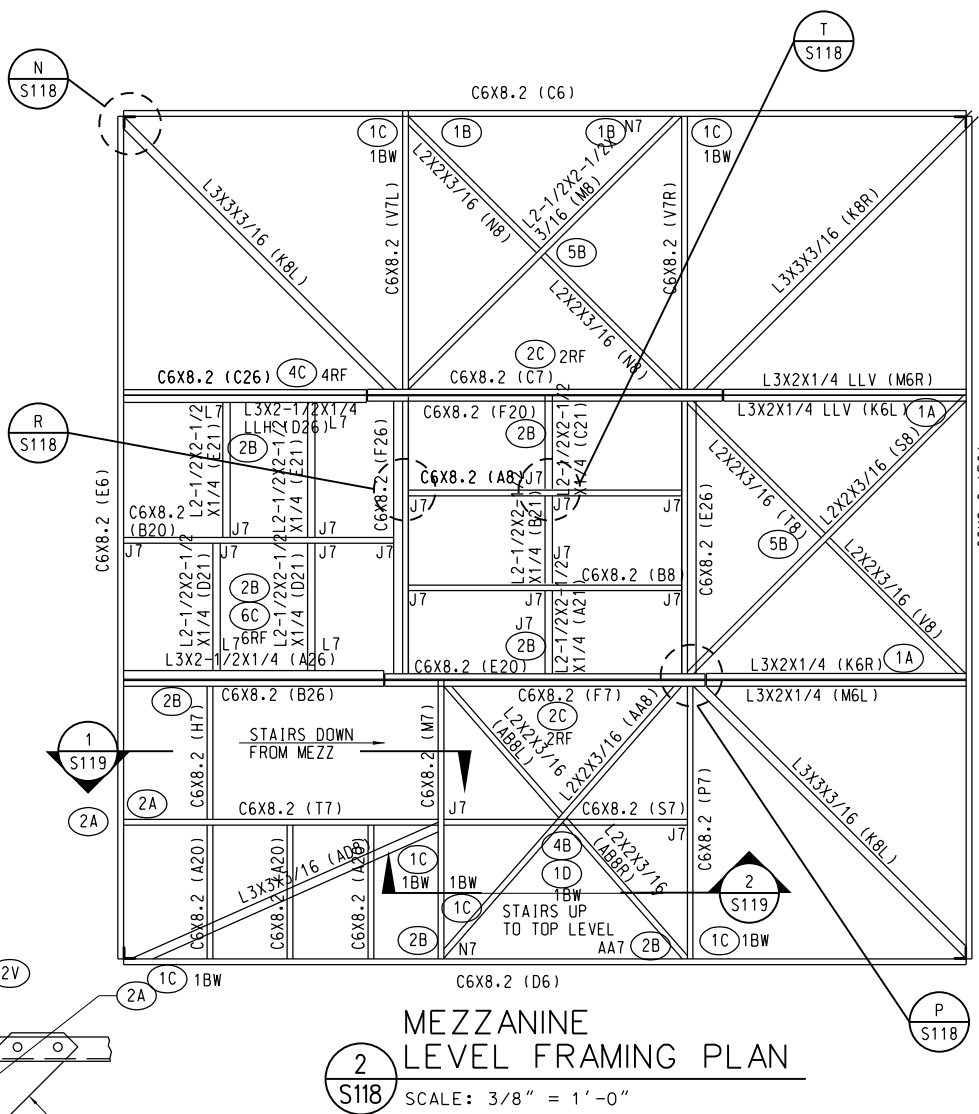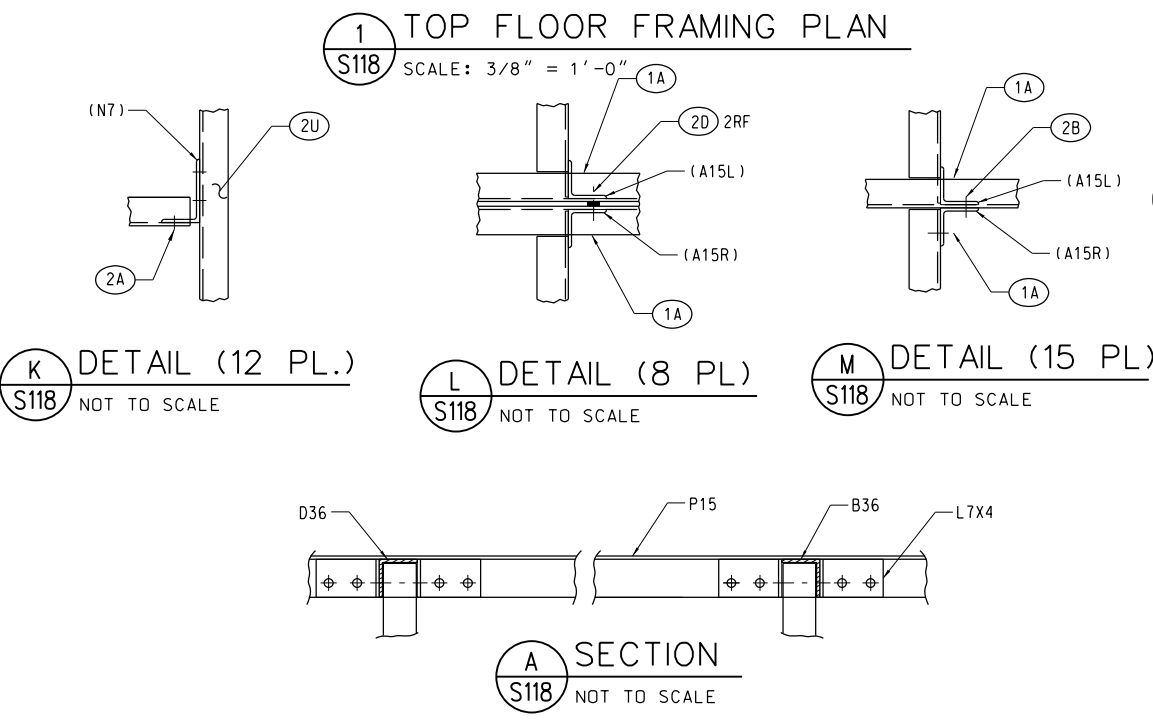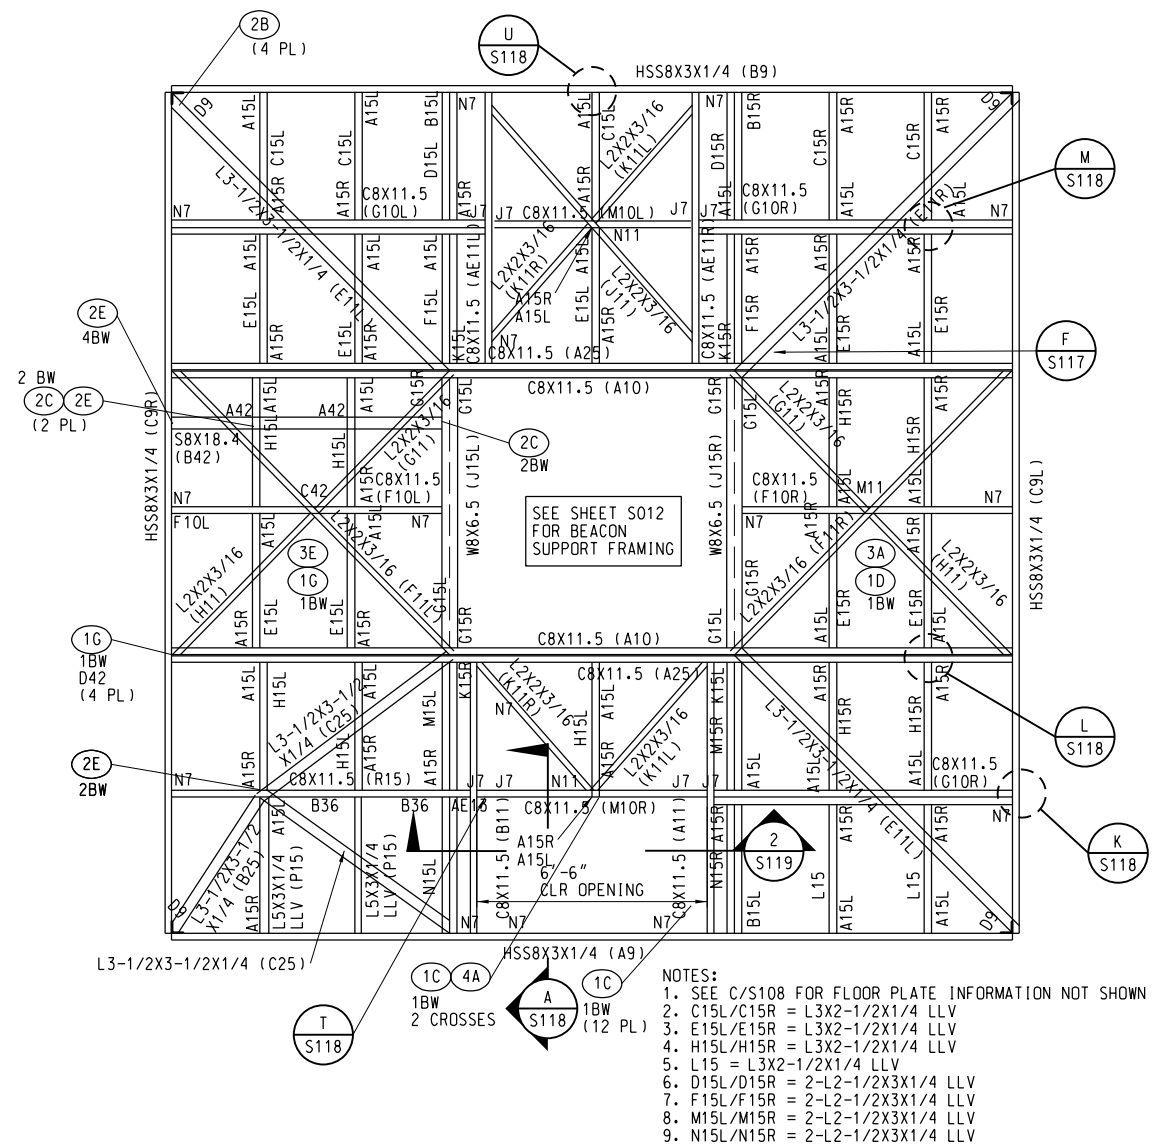


**NOTES**


- ALL STEEL HAS BEEN FABRICATED WITH THE EXCEPTION OF THOSE MEMBERS NOTED "REPLACEMENT MEMBERS" ON PIECE SHEETS. CONTRACTOR IS RESPONSIBLE FOR VERIFYING ALL PIECES PRIOR TO THE START OF STEEL PLACEMENT.

SCALES SHOWN FOR 22" X 34" SHEET. ADJUST SCALES FOR OTHER SIZES.					
7000 CENTRAL PARKWAY, SUITE 1475 ATLANTA, GEORGIA 30328 HEI JOB NUMBER: 212042.00					
<b>DEPARTMENT OF TRANSPORTATION</b> <b>FEDERAL AVIATION ADMINISTRATION</b> ATO TECHNICAL OPERATIONS      EASTERN SERVICE AREA					
<b>ATCBI</b> <b>ATCBI-6</b> <b>TOP PLATFORM AND MEZZANINE</b> <b>FLOOR FRAMING PLANS</b>					
FREPORT REVIEWED BY		SUBMITTED BY <b>NEIL BOLEN</b>		APPROVED BY <b>STEVE BRADY</b>	
DESIGNED DRAWN CHECKED		ISSUED BY ENGINEERING SERVICES SURV/WEATHER		DATE 4/23/2012    JCN 621767 DRAWING NO <b>BHF-D-621767-S118</b>	

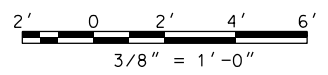


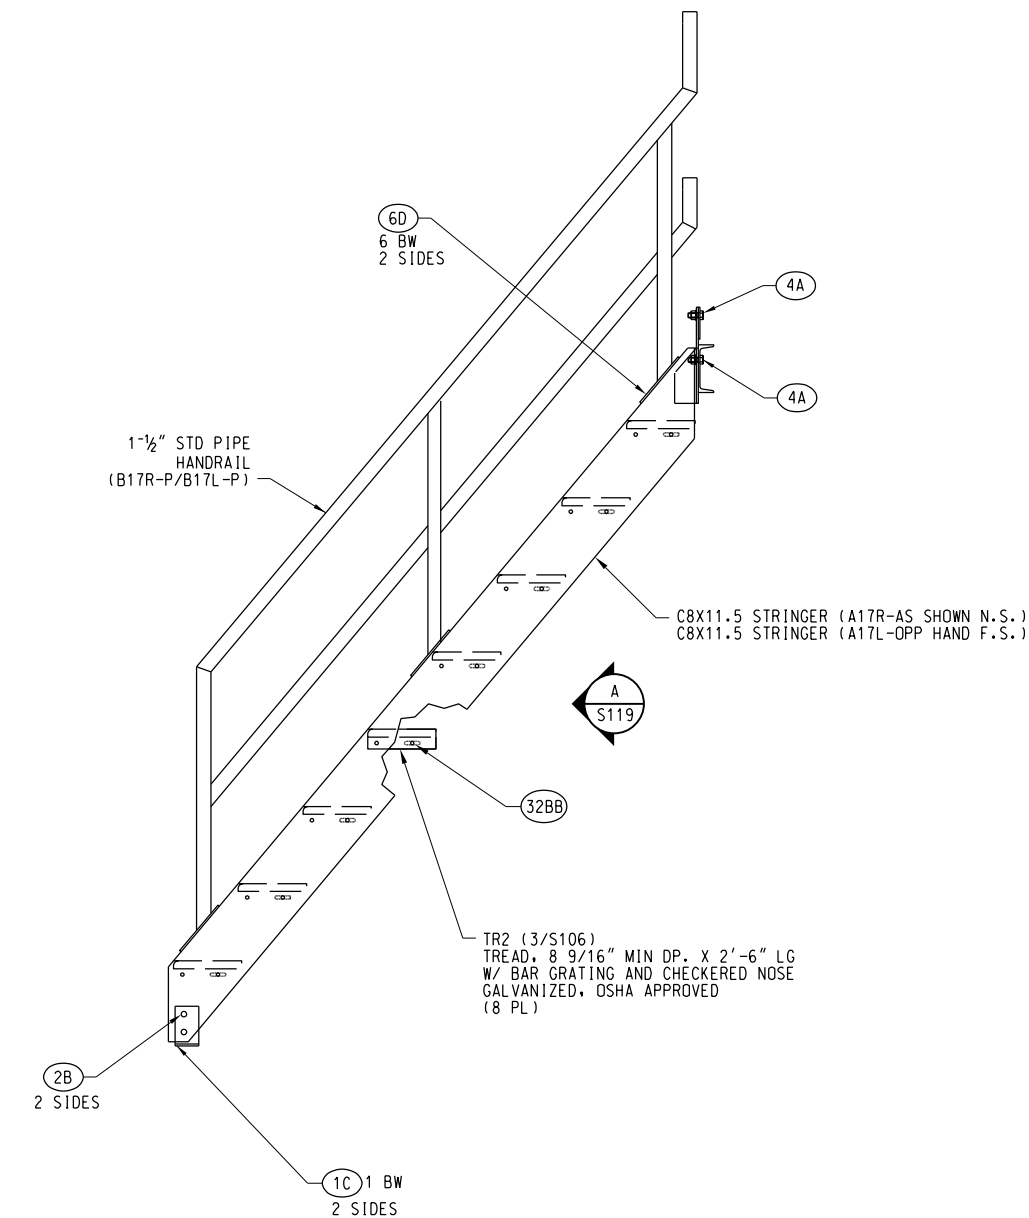

1 STAIR - BELOW MEZZANINE FLOOR  
S119 NOT TO SCALE

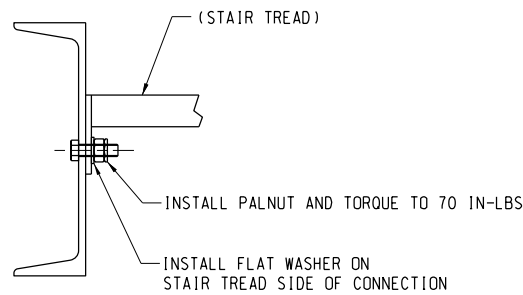

A SECTION  
S119 NOT TO SCALE

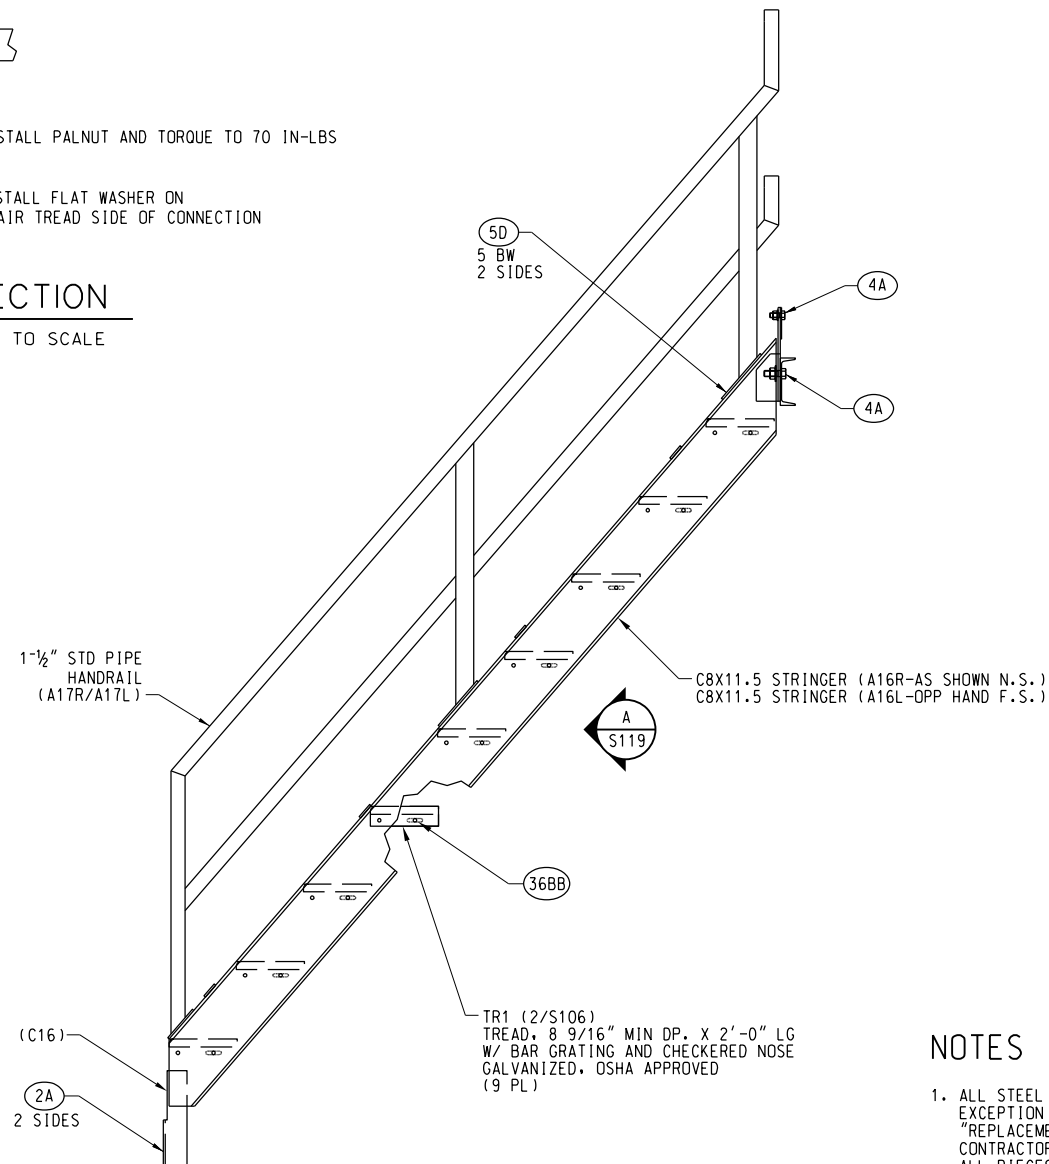


2 STAIR - MEZZANINE TO TOP PLATFORM  
S119 NOT TO SCALE

## NOTES


1. ALL STEEL HAS BEEN FABRICATED WITH THE EXCEPTION OF THOSE MEMBERS NOTED "REPLACEMENT MEMBERS" ON PIECE SHEETS. CONTRACTOR IS RESPONSIBLE FOR VERIFYING ALL PIECES PRIOR TO THE START OF STEEL PLACEMENT.

SCALES SHOWN FOR 22" X 34" SHEET. ADJUST SCALES FOR OTHER SIZES.									
<div><div><div>HARTRAMPF</div><div>7000 CENTRAL PARKWAY, SUITE 1475 ATLANTA, GEORGIA 30328 HEI JOB NUMBER: 212042.00</div></div><div><div>ATCBI ATCBI-6 MEZZANINE LEVEL STAIR &amp; HANDRAIL ELEVATIONS</div><div>FREEPORTBAHAMAS</div><div><div>REVIEWED BY</div><div>SUBMITTED BY NEIL BOLEN</div><div>APPROVED BY STEVE BRADDY</div></div><div><div>DESIGNED SNG</div><div>ISSUED BY ENGINEERING SERVICES SURV/WEATHER</div><div>DATE 4/23/2012</div><div>JCN 621767</div></div><div><div>DRAWN SNG</div><div>CHECKED RAB</div><div>DRAWING NO BHF-D-621767-S119</div><div>REV</div></div></div></div>									

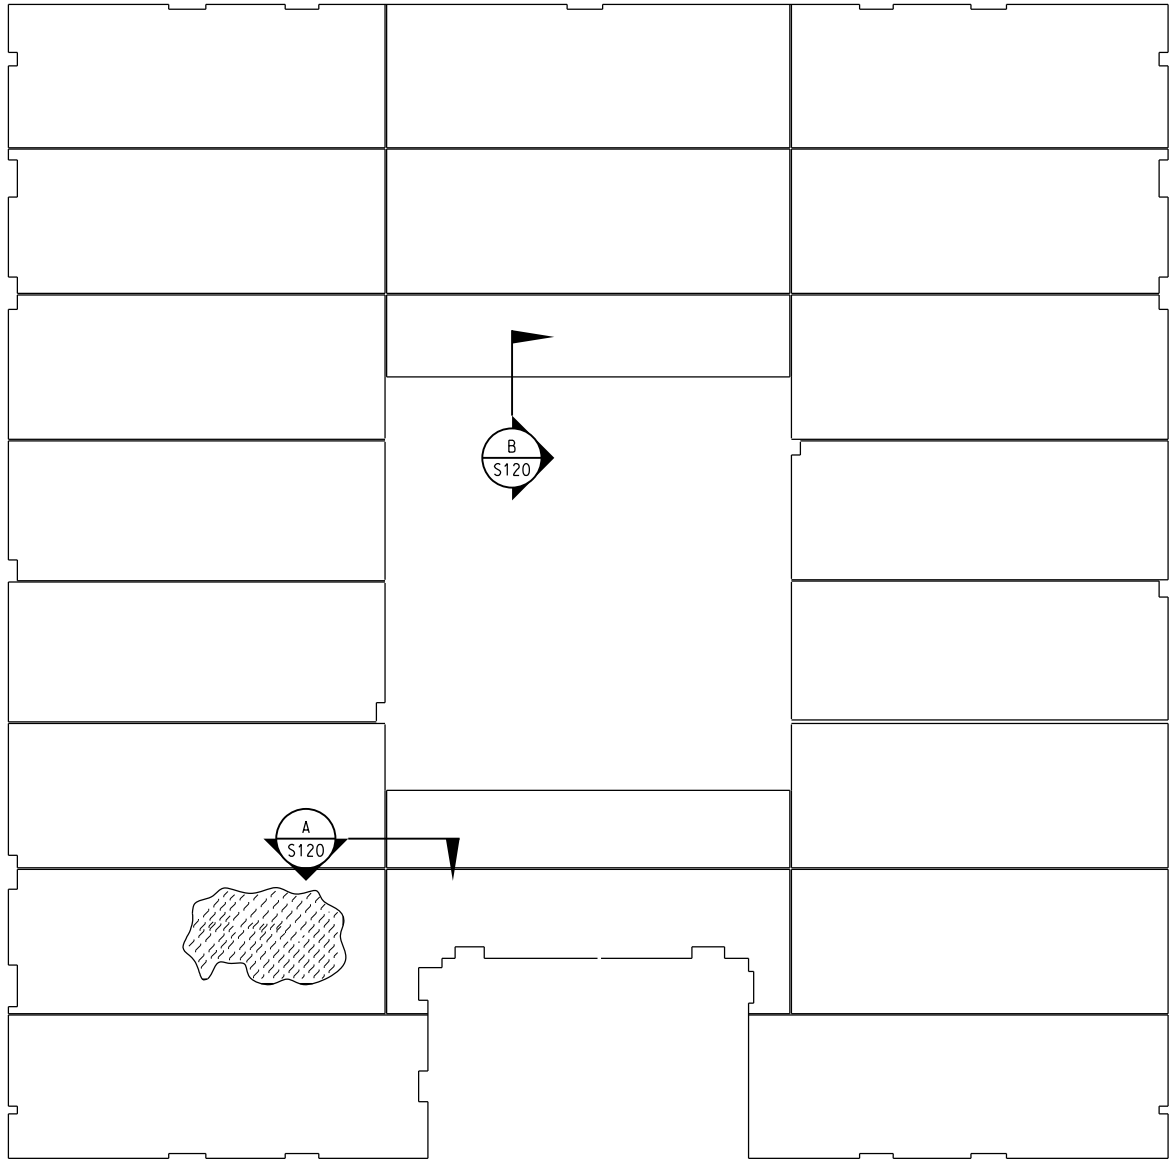


NOTE: SEE SHEET S027 FOR DECKING CALLOUTS AND DIMENSIONAL INFO NOT SHOWN.


1 TOP FLOOR TREADPLATE  
S120 SCALE: 1/2" = 1'-0"

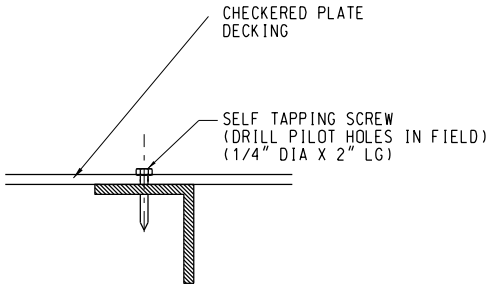


A SECTION  
S120 NOT TO SCALE

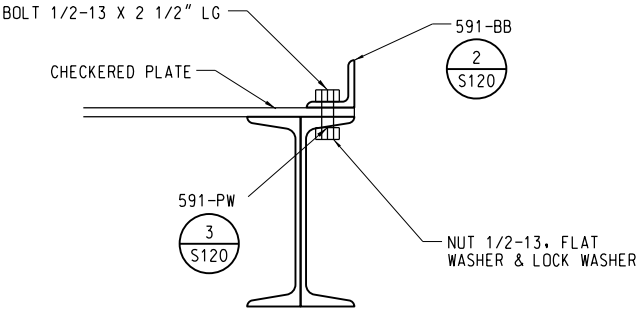

B SECTION  
S120 NOT TO SCALE

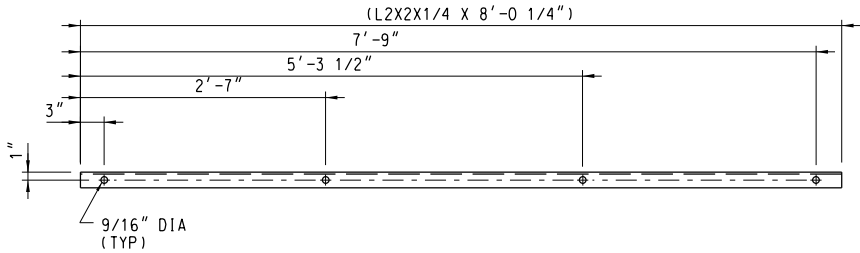



2 ANGLE - "591-BB"  
S120 NOT TO SCALE

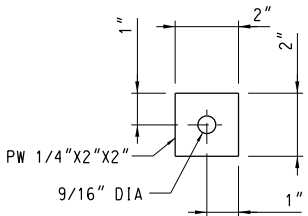


3 PLATE WASHER - "591-PW"  
S120 NOT TO SCALE

NOTES


1. ALL STEEL HAS BEEN FABRICATED WITH THE EXCEPTION OF THOSE MEMBERS NOTED "REPLACEMENT MEMBERS" ON PIECE SHEETS. CONTRACTOR IS RESPONSIBLE FOR VERIFYING ALL PIECES PRIOR TO THE START OF STEEL PLACEMENT.

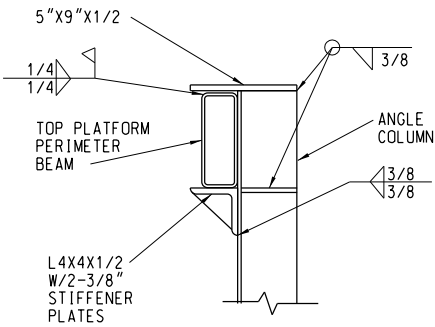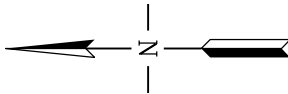


C SECTION  
S120 NOT TO SCALE

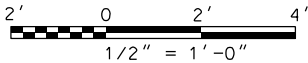

SCALES SHOWN FOR 22" X 34" SHEET. ADJUST SCALES FOR OTHER SIZES.																																	
<div><div><div>HARTRAMPF</div><div>7000 CENTRAL PARKWAY, SUITE 1475 ATLANTA, GEORGIA 30328 HEI JOB NUMBER: 212042.00</div></div><div><table><tr><td>REV</td><td>APPROVED DATE</td><td>DESCRIPTION</td><td>JCN</td><td>REDLINE DATE</td><td>APVD</td></tr><tr><td> </td><td> </td><td> </td><td> </td><td> </td><td> </td></tr><tr><td> </td><td> </td><td> </td><td> </td><td> </td><td> </td></tr><tr><td> </td><td> </td><td> </td><td> </td><td> </td><td> </td></tr></table></div></div>										REV	APPROVED DATE	DESCRIPTION	JCN	REDLINE DATE	APVD																		
REV	APPROVED DATE	DESCRIPTION	JCN	REDLINE DATE	APVD																												
DEPARTMENT OF TRANSPORTATION FEDERAL AVIATION ADMINISTRATION ATO TECHNICAL OPERATIONS EASTERN SERVICE AREA																																	
ATCBI ATCBI-6 TOP PLATFORM TREADPLATE LAYOUT																																	
FREEPORT BAHAMAS																																	
REVIEWED BY		SUBMITTED BY NEIL BOLEN			APPROVED BY STEVE BRADY																												
		DESIGNED SNG			ISSUED BY ENGINEERING SERVICES SURV/WEATHER		DATE 4/23/2012		JCN 621767																								
		DRAWN SNG					DRAWING NO		REV																								
		CHECKED RAB					BHF-D-621767-S120																										


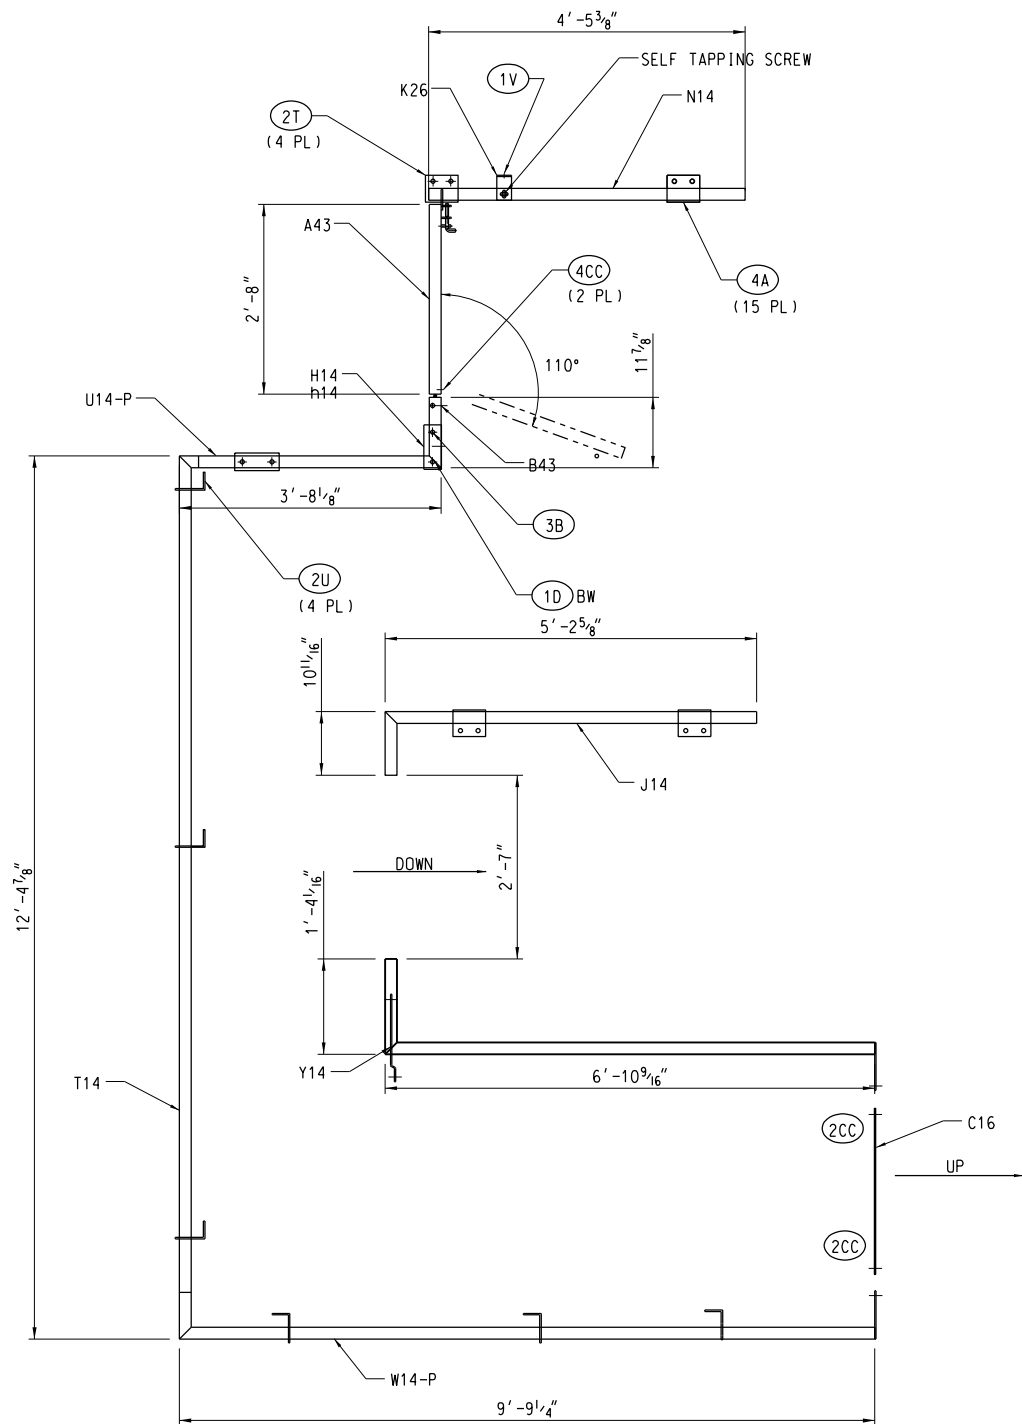


1 MEZZANINE HANDRAIL LAYOUT  
SCALE: 3/4" = 1' - 0"

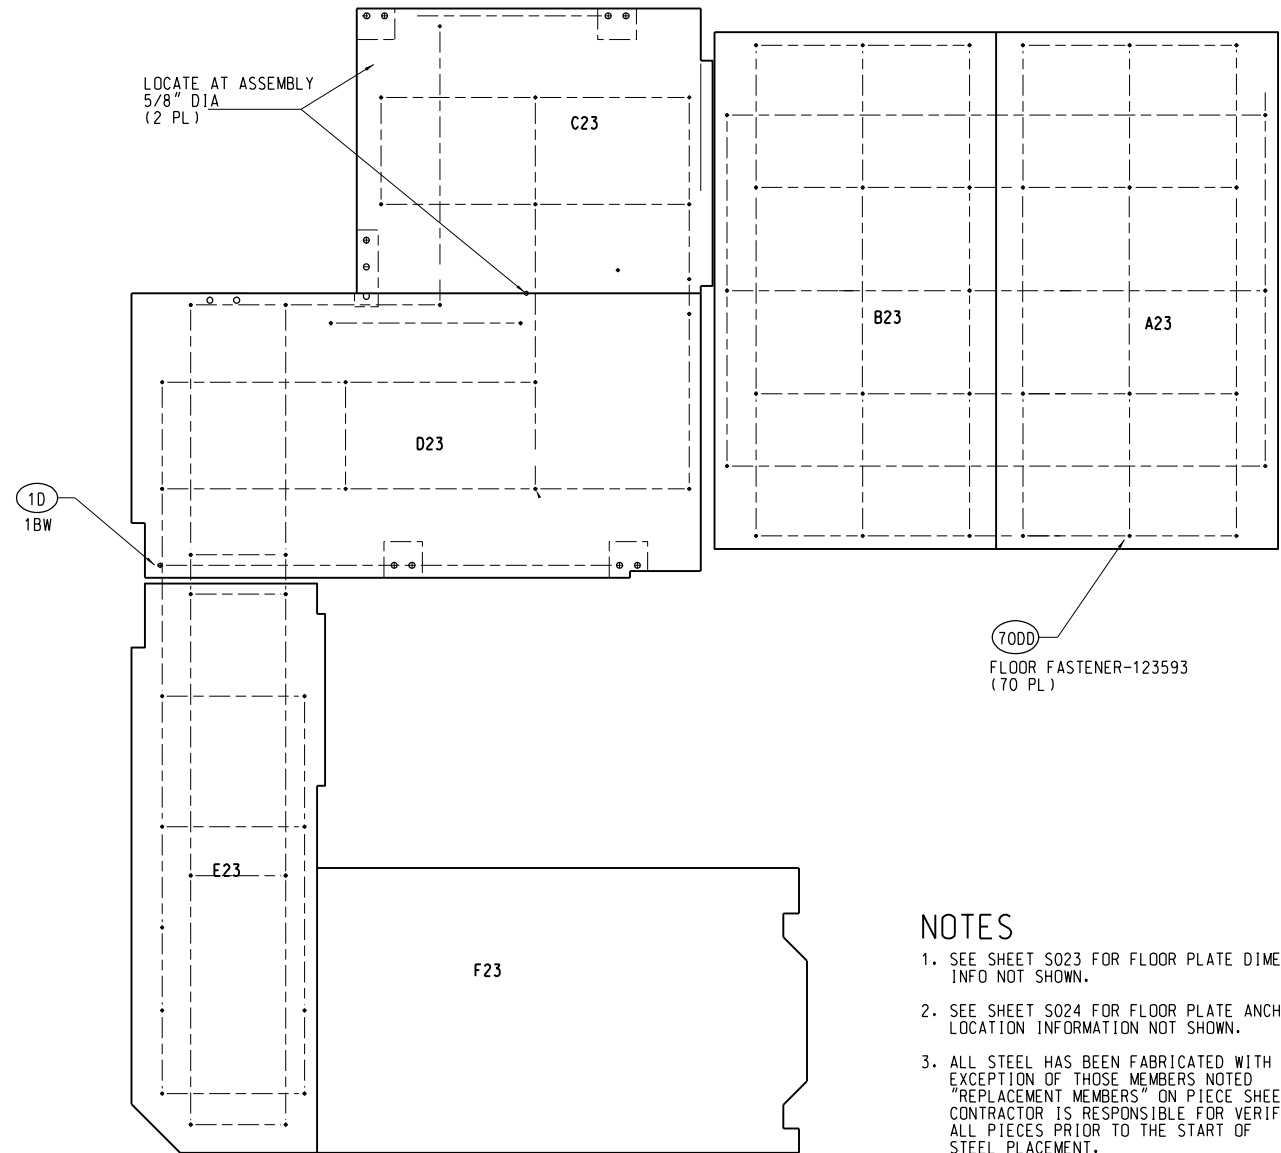


2 MEZZANINE FLOORING LAYOUT  
SCALE: 3/4" = 1' - 0"


- NOTES
- SEE SHEET S023 FOR FLOOR PLATE DIMENSIONAL INFO NOT SHOWN.
  - SEE SHEET S024 FOR FLOOR PLATE ANCHORAGE LOCATION INFORMATION NOT SHOWN.
  - ALL STEEL HAS BEEN FABRICATED WITH THE EXCEPTION OF THOSE MEMBERS NOTED "REPLACEMENT MEMBERS" ON PIECE SHEETS. CONTRACTOR IS RESPONSIBLE FOR VERIFYING ALL PIECES PRIOR TO THE START OF STEEL PLACEMENT.

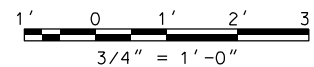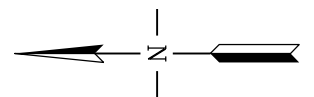


SCALES SHOWN FOR 22" X 34" SHEET. ADJUST SCALES FOR OTHER SIZES.									
7000 CENTRAL PARKWAY, SUITE 1475 ATLANTA, GEORGIA 30328 HEI JOB NUMBER: 212042.00									
DEPARTMENT OF TRANSPORTATION FEDERAL AVIATION ADMINISTRATION ATO TECHNICAL OPERATIONS EASTERN SERVICE AREA									
ATCBI ATCBI-6 MEZZANINE LEVEL TREADPLATE LAYOUT									
FREEPORT BAHAMAS									
REVIEWED BY SUBMITTED BY APPROVED BY STEVE BRADDY									
DESIGNED SNG ISSUED BY ENGINEERING SERVICES SURV/WEATHER									
DATE 4/23/2012 JCN 621767 DRAWING NO BHF-D-621767-S121 REV									

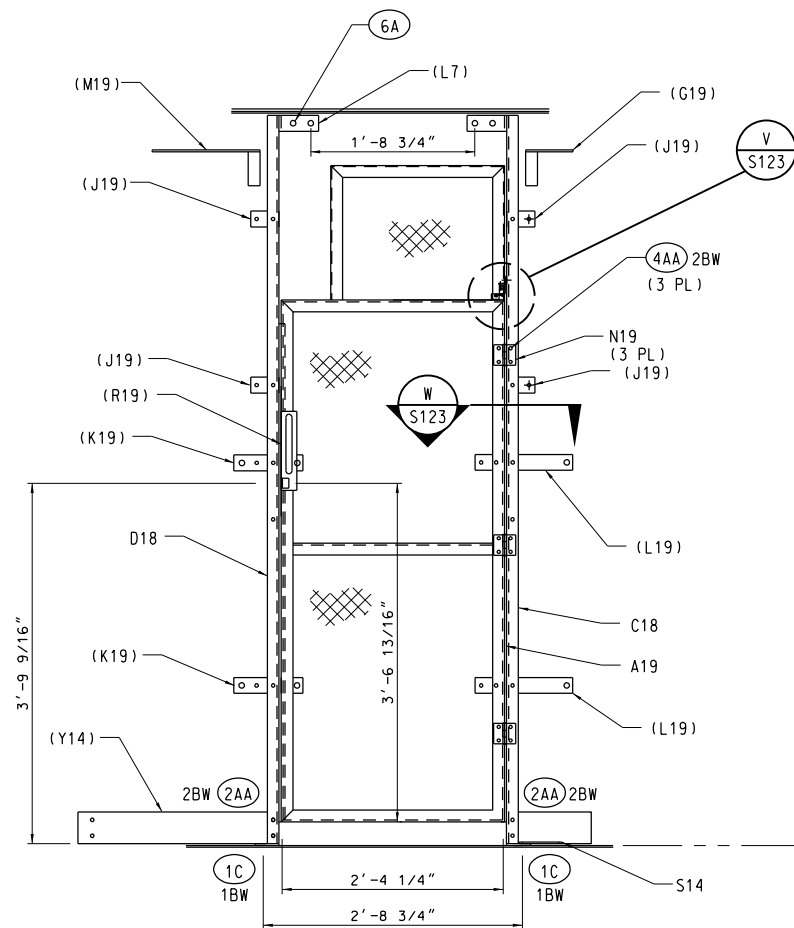

**B** VIEW  
S123 NOT TO SCALE

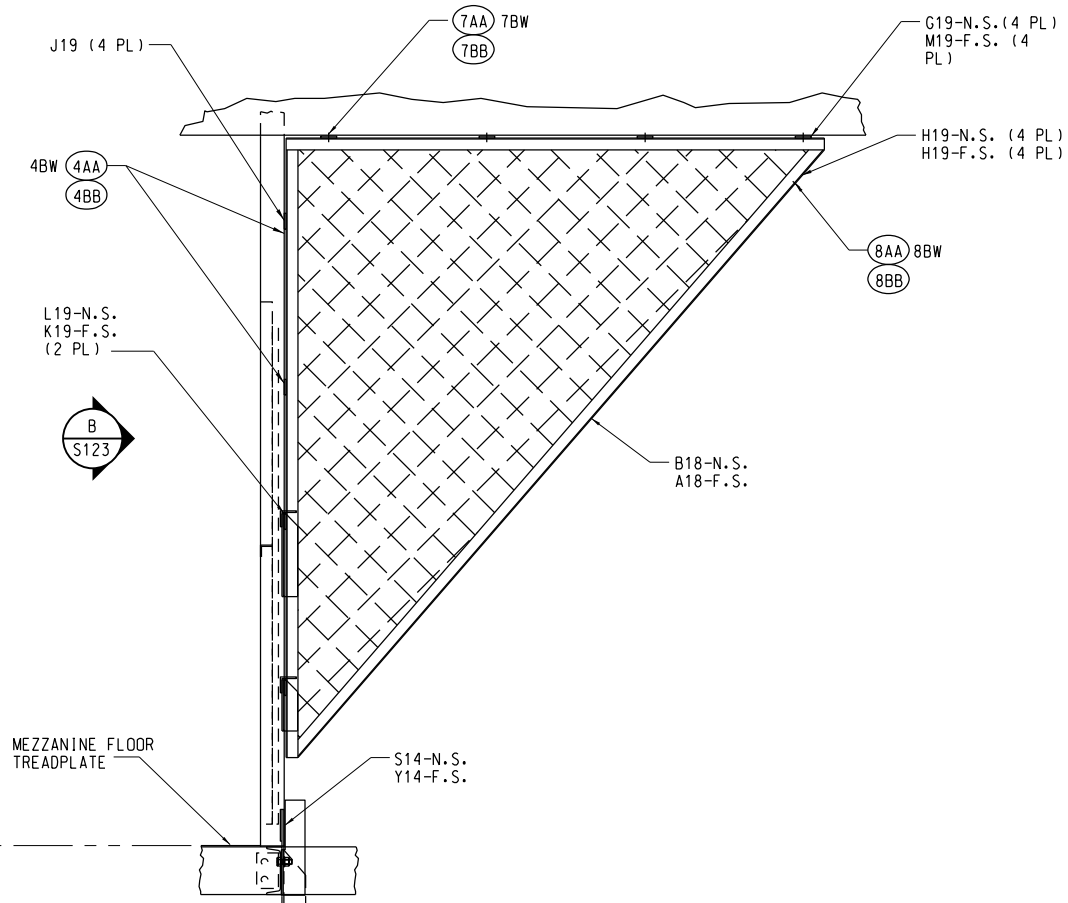

**J** MEZZANINE FLOOR TREADPLATE  
S123 NOT TO SCALE

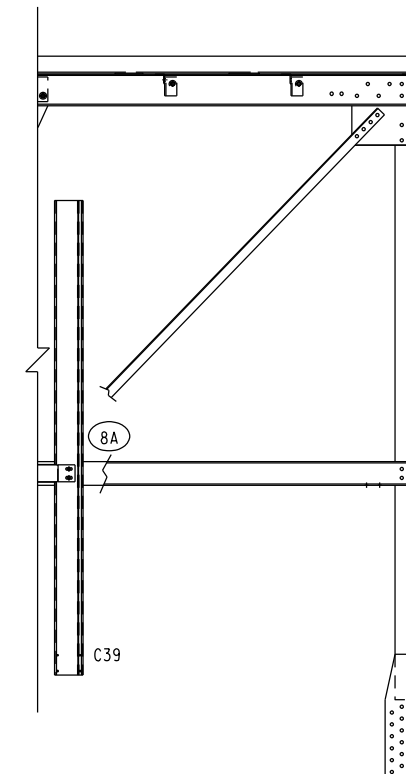


**A** CABLE TRAY DETAIL  
S123 NOT TO SCALE


NOTE: SEE SHEETS S116 & S117 FOR BRACING SIZES NOT SHOWN.

## NOTES

- ALL STEEL HAS BEEN FABRICATED WITH THE EXCEPTION OF THOSE MEMBERS NOTED "REPLACEMENT MEMBERS" ON PIECE SHEETS. CONTRACTOR IS RESPONSIBLE FOR VERIFYING ALL PIECES PRIOR TO THE START OF STEEL PLACEMENT.

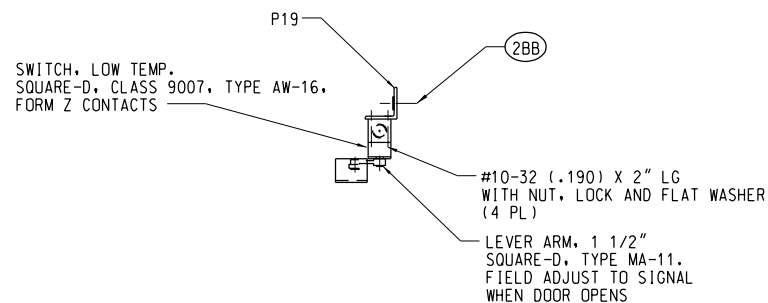


**V** DETAIL  
S123 NOT TO SCALE

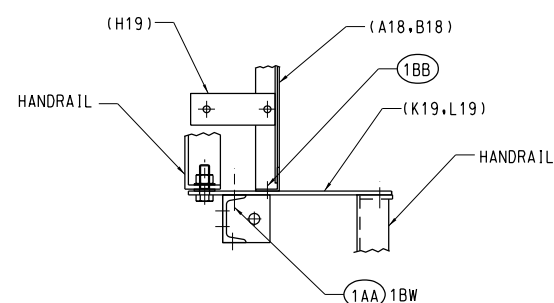

**W** DETAIL  
S123 NOT TO SCALE

SCALES SHOWN FOR 22" X 34" SHEET. ADJUST SCALES FOR OTHER SIZES.									
7000 CENTRAL PARKWAY, SUITE 1475 ATLANTA, GEORGIA 30328 HEI JOB NUMBER: 212042.00									
DEPARTMENT OF TRANSPORTATION <b>FEDERAL AVIATION ADMINISTRATION</b> ATO TECHNICAL OPERATIONS EASTERN SERVICE AREA									
ATCBI ATCBI-6 MEZZANINE LEVEL STAIR ACCESS DETAILS									
FREEPORT BAHAMAS									
REVIEWED BY		SUBMITTED BY				APPROVED BY			
		NEIL BOLEN				STEVE BRADY			
DESIGNED		SNG		ISSUED BY		DATE		JCN	
DRAWN		SNG		ENGINEERING SERVICES		4/23/2012		621767	
CHECKED		RAB		SURV/WEATHER		DRAWING NO		REV	
						BHF-D-621767-S123			

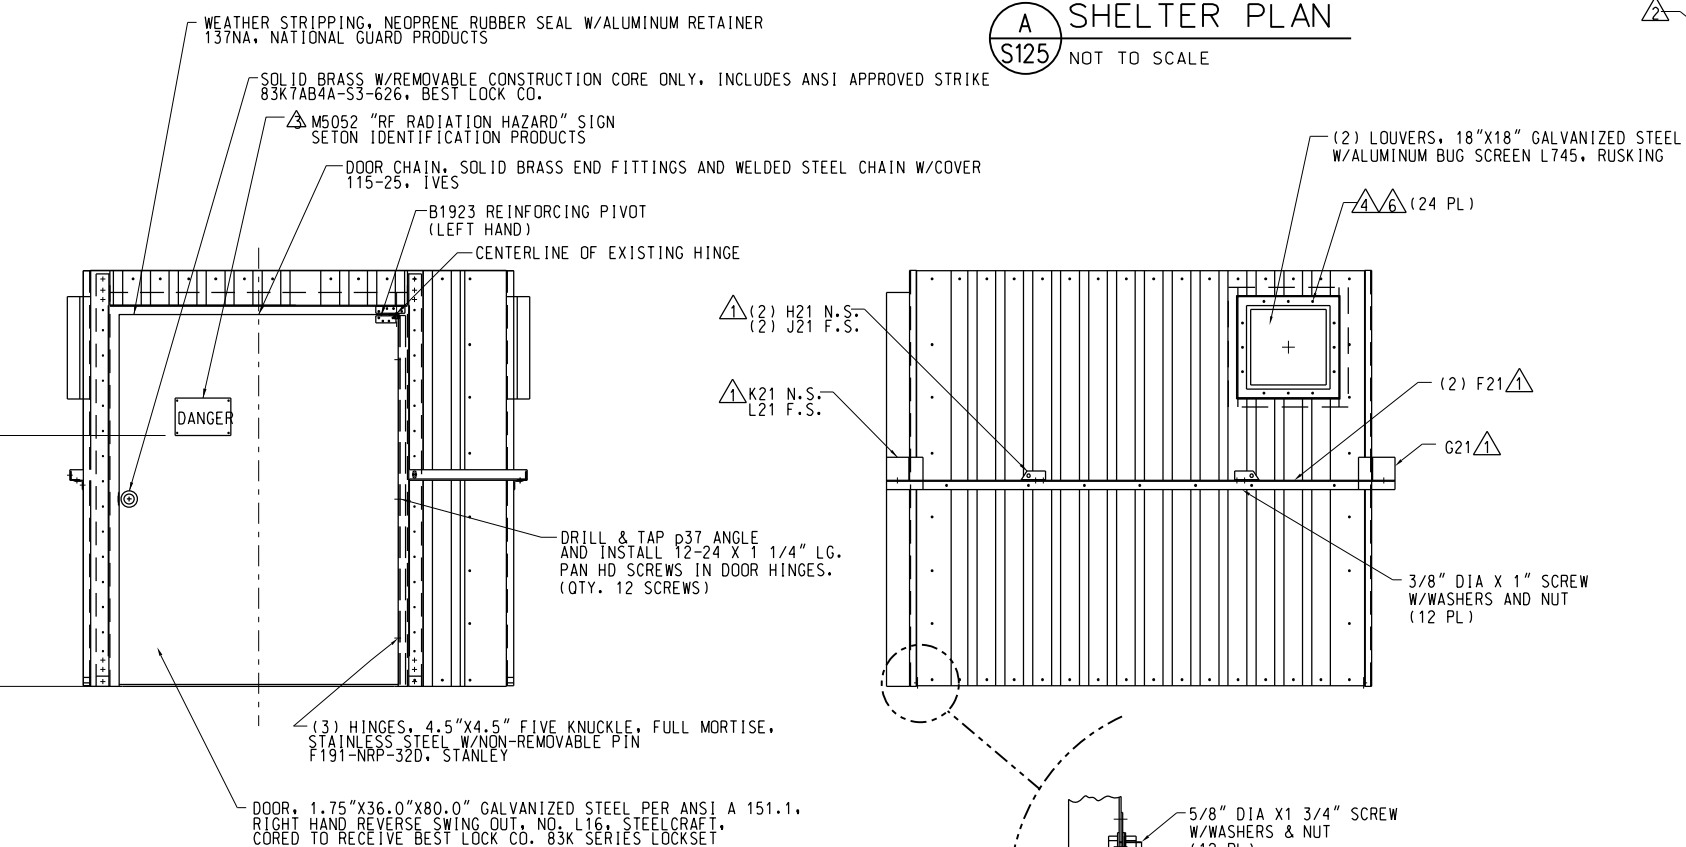


B ELEVATION  
S125 NOT TO SCALE

 ELEVATION  
NOT TO SCALE



1. SEE SHEET S037 AND S038, FOR PART DETAILS.
2. AT FINAL ASSEMBLY, CAULK ALL JOINTS WITH ALUMINUM G.E. SILICONE SEALANT 1209.
3. TEKS SCREWS, 10-16 X 3/4" LG, HEX WASHER HEAD TEKS/1, FASTEN AT 12" CENTERS. USE WITH AZTEC BONDED NEOPRENE/GALVANIZED STEEL SEALING WASHER. P/N E050020G, .200" I.D., .500" O.D.
4. TEKS SCREWS, 12-24 X 7/8" LG, HEX WASHER HEAD TEKS/4, FASTEN AT 6" CENTERS. USE WITH AZTEC BONDED NEOPRENE/GALVANIZED STEEL SEALING WASHER. P/N E056224G, .240" I.D., .562" O.D.
5. BREAK SCREW STEMS USING A HAMMER. APPLY COLD GALVANIZE PER COMSAT-RSI DRAWING 119730.
6. MATCH DRILL LOUVER/PANEL TO FRAME EQUALLY SPACED. 12 PLACES MIN.
7. PAINT USING CARBOLINE CO. POLYURETHANE 134HS, COLOR 2716 (SILVER-GRAY)
8. ALL STEEL HAS BEEN FABRICATED WITH THE EXCEPTION OF THOSE MEMBERS NOTED "REPLACEMENT MEMBERS" ON PIECE SHEETS. CONTRACTOR IS RESPONSIBLE FOR VERIFYING ALL PIECES PRIOR TO THE START OF STEEL PLACEMENT.

SEE SEPARATE PARTS LIST SHEET S124


SCALES SHOWN FOR 22" X 34" SHEET. ADJUST SCALES FOR OTHER SIZES.									
									
7000 CENTRAL PARKWAY, SUITE 1475 ATLANTA, GEORGIA 30328			REV	APPROVED DATE	DESCRIPTION	JCN	REDLINE DATE	APVD	
DEPARTMENT OF TRANSPORTATION <b>FEDERAL AVIATION ADMINISTRATION</b> ATO TECHNICAL OPERATIONS      EASTERN SERVICE AREA									
ATCBI ATCBI-6 MEZZANINE LEVEL EQUIPMENT ROOM DETAILS									
FREEPORT      BAHAMAS									
REVIEWED BY			SUBMITTED BY  NEIL BOLEN			APPROVED BY  STEVE BRADY			
			DESIGNED      SNG			DATE    4/23/2012		JCN      621767	
			DRAWN      SNG			DRAWING NO		REV	
			CHECKED      RAR			BHF-D-621767-S125			
			SURV/WEATHER						



NOTES:

1. ACCEPTABLE MATERIALS:
- A. 0.03 INCH MIN. ALUMINUM, REVERSED ETCHED PROCESS. THE BORDER, SERIAL NUMBER, REVISION AND DATE BLANKS SHALL HAVE A DULL METAL FINISH. ALL LETTERS AND NUMBERS SHALL HAVE A DEPRESSED BACKGROUND FINISHED IN BLACK ENAMEL.

B. 0.02 INCH MIN. PHOTSENSITIVE ANODIZED ALUMINUM PROCESSED FOR WHITE METAL CHARACTERS WITH JET BLACK BACKGROUND. IMAGE SHALL BE SEALED IN OXIDE LAYER BY CHEMICAL TREATMENT.
2. LETTERS SHALL BE .10 INCH HIGH GOTHIC OR FUTURA CAPITALS, WITHOUT SERIFS. NUMERALS SHALL BE .10 HIGH ARABIC.
3. SERIAL NUMBERS: ENGRAVE OR DIE STAMP AT NEXT ASSEMBLY.
4. TOLERANCE ON DIMENSIONS +/- 0.010 INCH, EXCEPT HOLE SIZE AND HOLE TO HOLE SPACING +/- 0.005 INCH.
5. CHARACTER GROUPS TO BE CENTERED.

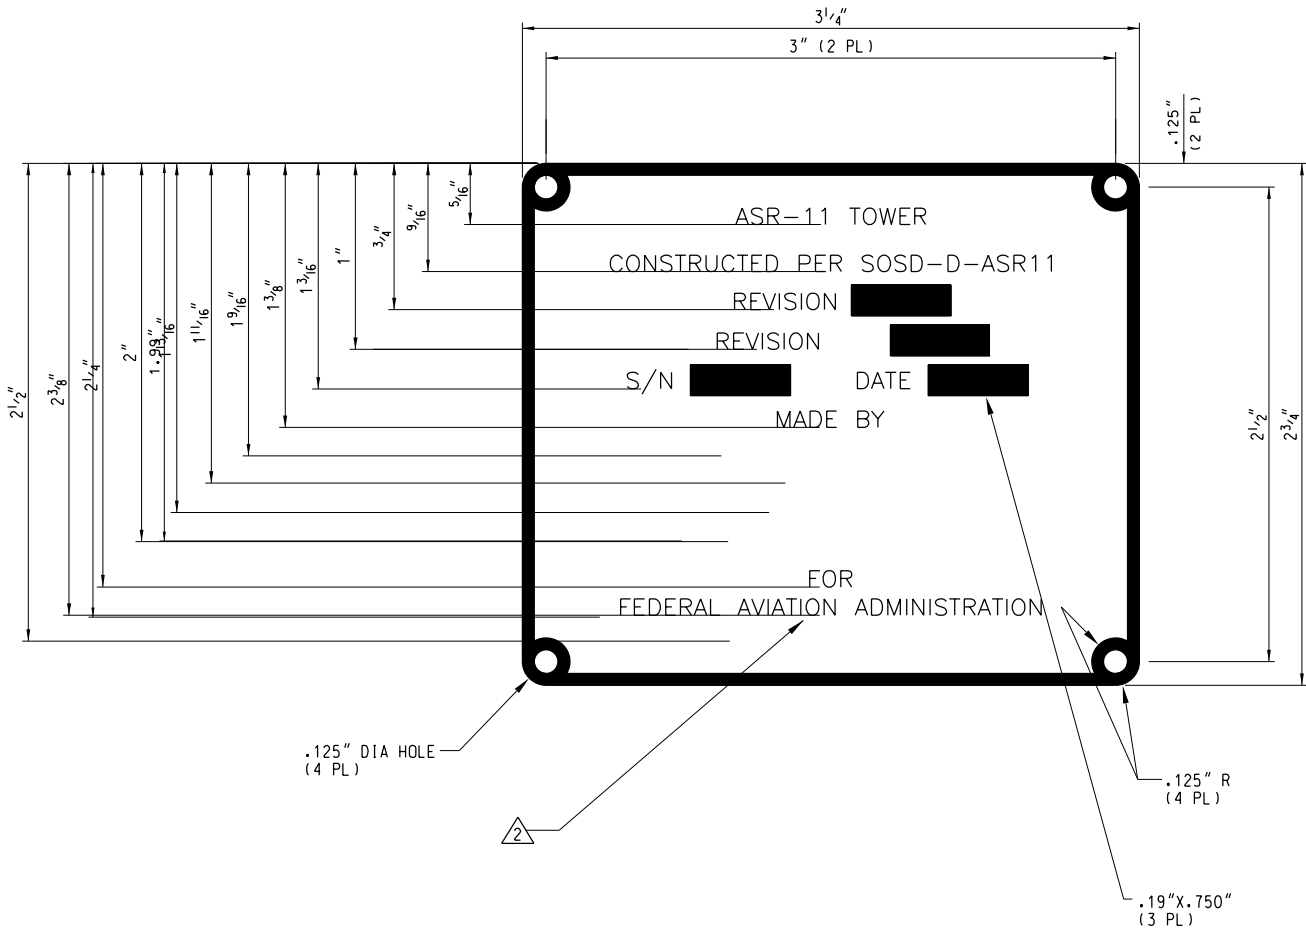

SCALES SHOWN FOR 22" X 34" SHEET. ADJUST SCALES FOR OTHER SIZES.									
<div>HARTRAMPF</div> <div>7000 CENTRAL PARKWAY, SUITE 1475 ATLANTA, GEORGIA 30328</div> <div>HEI JOB NUMBER: 212042.00</div>									
REV	APPROVED DATE	DESCRIPTION			JCN	REDLINE DATE	APVD		
DEPARTMENT OF TRANSPORTATION FEDERAL AVIATION ADMINISTRATION ATO TECHNICAL OPERATIONS EASTERN SERVICE AREA									
ATCBI ATCBI-6 PLATE IDENTIFICATION									
FREEPORT BAHAMAS									
REVIEWED BY		SUBMITTED BY			APPROVED BY				
		NEIL BOLEN			STEVE BRADY				
		DESIGNED SNG		ISSUED BY		DATE 4/23/2012		JCN 621767	
		DRAWN SNG		ENGINEERING SERVICES		DRAWING NO		REV	
		CHECKED RAB		SURV/WEATHER		BHF-D-621767-S126			